SH SMART HOMES

2750, 2752 & 2754 E. 20TH STREET, SIGNAL HILL CA. 90755 THREE HOMES CONDOMINIUM SUBDIVISION TM 082172 HOUSE "A" MODIFICATIONS - PRELIMINARY PLANS

SCOPE OF WORK: DEMOLITION OF (E) ONE-STORY HOUSE, DETACHED GARAGE AND SEPTIC TANK UNDER SEPARATE PERMIT, NOT INCLUDED. 2 CONSTRUCTION OF THREE NEW HOMES 3. NEW RETAINING WALLS, FENCES, GATES LINDER SEPARATE PERMIT 4 NEW STORMWATER RETENTION PLANTERS 5. RE-PAVING OF EXISTING "L" SHAPE ALLEY UNDER SEPARATE PERMIT 6. NEW WATER, POWER & TELECOM PIPES & CONDUITS 9. INSTALLATION OF RECOMMENDED METHANE BARRIER UNDER SEPARATE PERMIT 10. NEW LANDSCAPING 11. NEW ON SITE FIRE ACCESS DRIVEWAY

ALLEY WORK DESCRIPTION

PRELIMINARY DESCRIPTION IS PROVIDED ONLY AS GENERAL RESPONSE TO ADJACENT HOMEOWNERS QUESTIONS, FOR ALLEY AND UTILITIES PLANS REFER TO CIVIL ENGINEER AND UTILITY PROVIDERS DRAWINGS AND SPECIFICATIONS.

- 2. (N) WATER, CONDUITS SHALL BE LAID IN TRENCHES PER CITY OF SIGNALL HILL STANDARDS.
- PROPOSED PROCEDURES FOR ACCESS TO GARAGES: WHEN BACKFILL OPERATIONS CAN NOT BE COMPLETED BY THE END OF AUTHORIZED WORK SHIFT, STEEL PLATES SHALL BE USED TO TEMPORARILY COVER THE EXCAVATION.
- 4. STEEL PLATES STRUCTURAL DESIGN SHALL BE PREPARED BY PROFESSIONAL ENGINEER.
- 5. TRAFFIC CONTROLS SHALL BE PLACED PER CITY OF SIGNALL HILL REQUIREMENTS.
- 6. CLOSURE OF ALLEY TO TRAFFIC AND PARKING DURING WORK SHIFT OR PARTIAL CLOSURE WHEN FEASIBLE WILL BE REQUIRED DURING EXISTING PAVEMENT REMOVAL, AND NEW PAVING PLACEMENT
- BUILDER SHALL COORDINATE WITH PUBLIC WORK DEPARTMENT RESERVED STREET PARKING FOR AFFECTED RESIDENTS DURING ALLEY CLOSURE.
- 8. BUILDER SHALL PLACE SIGN: "PLEASE DO NOT DRIVE ACROSS WORK AREAS, AS THAT MAY DAMAGE THE NEW PAVEMENT AND
- CONTRACTOR BUILDER SHALL PROVIDE ALLEY CONSTRUCTION SCHEDULE AND PROCEDURE DESCRIPTION AND COORDINATE WITH ADJACENT HOMEOWNERS.
- 11. CONTRACTOR/BUILDER SHALL PROVIDE REQUIRED SIGNAGE INCLUDING #8 AND #9

ARCHITECT'S HAZARDOUS MATERIALS DISCLAIMER

- OIL WELL ABANDONMENT, METHANE TESTING, METHANE GAS MITIGATION SYSTEM, AND OTHER ENVIRONMENTAL MITIGATION AND
 PERMITTING ARE NOT PART OF THESE PLANS. ANY ENVIRONMENTAL INFORMATION IS SHOWN FOR REFERENCE ONLY.
- 2. ARCHITECT IS NOT LIABLE FOR PERFORMANCE OF OWNER'S, ENVIRONMENTAL CONSULTANTS AND GOVERNMENTAL AGENCIES.
- 3. THE BUYER'S OF CONDOMINIUM HOMES AND HOMEOWNERS ASSOCIATION AGREE AND EXPRESSLY ACKNOWLEDGE THAT THE PROFESSIONALS WHO PREPARED THE ARCHITECTURAL PLANS ACCEPT NO RESPONSIBILITY FOR THE ACCURACY OR COMPLETENESS OF THE ENMRONMENTAL TESTS, REPORTS AND OTHER DOCUMENTS, AND THE DESIGN PROFESSIONALS WHO PREPARED THESE PLANS DISCLAIM ALL WARRANTIES, EXPRESSES OR IMPLIED, WITH RESPECT TO THE PLANS AND BUYERS
- 4. ARCHITECT MAKES NO REPRESENTATION OR WARRANTY AS THE FOLLOWING: (i) THAT THE EXISTING WELL WILL NO LEAK METHANE CAS. (ii) THAT THE EXISTING WELL IS IN SUITABLE CONDITION FOR THE PROPOSED USE OF THE PROPERTY. (iii) THAT THE EXISTING WELL WILL NO PRESENT ANY HEALTH OR SAFETY CONCERNS NOW OR IN THE FUTURE. ARCHITECTS MAKES NO REPRESENTATION OR WARRANTY RELATED TO THE EXISTING WELL BY VIRTUE OF ITS PROVIDING ARCHITECT SERVICES.
- 5. GOVERNMENTAL AGENCIES REQUIRE OWNER/DEVELOPER/BUILDER TO:
- A TEST EXISTING STRUCTURES BEFORE DEMOLITION FOR THE PRESENCE OF ASBESTOS AND LEAD; HAVE A LICENSED CONTRACTOR TO PERFORM ABATEMENT IN COMPLIANCE WITH WITH GOVERNING REGULATIONS
- B. COMPLY WITH CITY OF SIGNAL HILL OIL AND GAS CODE REQUIREMENTS FOR ABANDONED OIL WELLS; AND ALL OTHER APPLICABLE LAW AND REGULATIONS.
- C. ORDER A METHANE SITE ASSESSMENT AND COMPLY WITH RECOMMENDATIONS
- D. INSTALL GAS METHANE SYSTEM BARRIER AND VENTILATION
- E. SUBMIT PROJECT PLANS TO CALGEM FOR REVIEW
- F. RETAIN CONSULTANT TO PREPARE A SOIL MANAGEMENT PLAN PRIOR TO ANY GRADING ACTIVITIES, TO PROVIDE INSTRUCTIONS FOR THE CONTRACTOR HOW TO PROCEED IN THE EVENT DISCOVERY OF THE DISCOLORED OR ODIFEROUS SOIL, OR UNKNOWN DEBRIS.

LOT 9 LEGAL DESCRIPTION

LOT 9 OF THE PRICE AND PETERSEN TRACT, COUNTY OF LOS ANGELES, STATE OF CALIFORNIA, AS PER MAP RECORDED IN BOOK 12, PAGE(5) 85 OF MAPS, INCLUDING THAT PORTION OF THE 15 FOOT ALLEY ABUTTING SAID LAND, BETWEEN LOTS 4,5,6 and 10 10 ACAGET BY RESOLUTION NO.159, CITY OF SIGNAH. HILL, COUNTY OF LOS ANGELES, STATE OF CALIFORNIA, EXCEPT THE EASTERLY 7.5 FEET OF THAT PORTION OF THE ALLEY AWACATED BY RESOLUTION NO. 159 OF THE CITY OF SIGNAH HILL, BEING A PORTION OF THE ALLEY SHOWN OF THE MAP OF THE PRICE AND PETERSEN TRACT, ADOLINING LOTS 4.5 AND 6 OF

ZONING INFORMATION

ASSESSOR'S PARCEL NO.: 7216-20-12

LOT 10 LEGAL DESCRIPTION

LOT 10 OF THE PRICE AND PETERSEN TRACT, COUNTY OF LOS ANGELES, STATE OF CALIFORNIA, AS PER MAP RECORDED IN BOOK 12, PAGE(S) 85 OF MAPS, INCLUDING THAT PORTION OF THE 15 FOOT ALLEY ABUTTING SAID LAND, BETWEEN LOTS 4,5,6 AND 10 VACATED BY RESOLUTION NO.159, CITY OF SIGNA HILL, COUNTY OF LOS ANGELES, STATE OF CALIFORNIA, EXCEPT THE ESTERLY 7.5 EET OF THAT PORTION OF THE 15 FOOT ALLEY, VACATED BY RESOLUTION NO. 159 OF THE CITY OF SIGNAL HILL BEING A PORTION OF THE ALLEY SHOWN ON THE MAP OF THE PRICE AND PETERSEN TRACT, ADJOINING LOTS 4,5 AND 6 OF

PROJECTIONS ARCH. DETAILS

BUILDING AREA PLAN "B" & "BR"

FIRST FLOOR

TOTAL LIVING

PARKING PROVIDED: GARAGES 6

T AND REAR YARD 30

1,350 S.F. 2,317 S.F.

ASSESSOR'S PARCEL NO.: 7216-20-12

TOTAL LOT AREA AFTER PARCEL MAP:

ZONE: RH			
ZONING STANDARDS	REQUIRED		
HEIGHT	2½ STORY	25' / MAX	
PROPOSED:		,	
HOUSE A - ONE STORY H	IEIGHT 12'-8"		
HOUSE B & BR -SPLIT LE	EVEL HEIGHT VA	RIES 10' TO	25'
orrane.	DEGUIDED	2001425	MODIFIE
SETBACKS:	REQUIRED	PROVIDED	MODIFIE
HOUSE A, ALLEY YARD	10'	18'-0"	10"

5'-1" 26'-3" HOUSE B WEST SIDE 5-1" 7'-0" & 13'-0"

DOOL BY EVEL SIDE		14-10
BUILDING AREA PLAN "A"		MODIFIED
FIRST FLOOR	2,010 S.F.	
GARAGE	489 S.F.	474 S.F.

DENSITY CALCULATION: TOTAL LOT AREA> 10,000 S.F.

PARKING REQUIRED: 3 SPACES PER 3 BEDROOM UNIT= 9 SPACES

1 GUEST PER 4 UNITS= 1 SPACE TOTAL REQUIRED 10 SPACES

LOT COVERAGE CALCS

HOUSE	FOOTPRINT	DECI	KS		MODIFIED FOOTPRINT	
A	2,517 S.F	ī. —			2,397	S.F.
В	1,512 S.F					
DECK			173	S.F.		
BR	1,512 S.F					
DECK			173	S.F.		
TOTAL	5,541 S.F		346	S.F.		
LOT COVE	RAGE TOTAL		5,887	S.F.	5,767	S.F.
LOT AREA %	13,650 S.F	1	43.1%		42.2%	
	IG INCLUDED LOT COVERAGE:	50%				

PLANING NOTES

- ALL EXISTING OVERHEAD UTILITIES EXCLUSIVELY SERVING THE SITE SHALL BE REMOVED AND ALL NEW ON SITE UTILITIES TO
- PAD ELEVATION IS TO BE VERIFIED BY A LICENSED SURVEYOR OR CIVIL ENGINEER PRIOR TO REQUESTING A FOUNDATION INSPECTION.
- BUILDING HEIGHT IS TO BE VERIFIED BY A LICENSED SURVEYOR OR CIVIL ENGINEER PRIOR TO REQUESTING A FOUNDATION
- 4. ALL EXPOSED METAL FLASHING OR TRIM TO BE ANODIZED OR PAINTED TO MATCH BUILDING EXTERIOR.
- 5. CARAGE MUST BE PROVIDED WITH AUTOMATIC ELECTRONIC GARAGE OPENERS.
- 6. RODE TOP FOLIPMENT AND VENT STACKS SHALL BE PAINTED A NEUTRAL COLOR, SO AS TO NOT NEGATIVELY IMPACT VIEWS FROM THE PUBLIC RIGHT-OF-WAY, SUCH EQUIPMENT SHALL BE PAINTED AND/OR SCREENED SUBJECT TO THE APPROVAL OF THE PLANNING DEPARTMENT BASED ON FIELD INSPECTION.
- FINAL ADEQUACY OF LANDSCAPE MATERIALS AND COVERAGE IS SUBJECT TO FIELD INSPECTION BY PLANNING DEPT. STAFF.
 ADDITIONAL LANDSCAPING FOUND NECESSARY UPON INSPECTION SHALL BE INSTALLED BY APPLICANT PRIOR TO OCCUPANCY.
- 8. EXTERIOR LIGHTING SHALL BE SHIELDED / DIRECTED SO AS NOT TO IMPACT ADJACENT PROPERTIES.
- 9. EACH DWELLING MUST BE PROVIDED WITH 72 CU.FT. OF STORAGE AREA. THIS STORAGE MAY BE PROVIDED IN THE GARAGE

BUILDING CODE DATA

PROPOSED NEW CONSTRUCTION: THREE DETACHED CONDOMINIUM HOMES.

OCCUPANCY GROUP R DIVISION :

CLIMATE ZONE 6 SEISMIC HAZARD ZONE

WIND LOAD 110 MPH

EXPOSURE C

PROJECT DIRECTORY

OWNER/APPLICANT: NARSIMHA REDDY 123 ATLANTIC AVE

LONG BEACH, CA. 90802

DESIGN ARCHITECT: RPP ARCHITECTS & ASSOCIATES, INC. 5199 E PACIFIC COAST HWY, LONG BEACH, CA 90804

ARCHITECT OF RECORD MAA ARCHITECTS, INC. 3146 TIGER RUN COURT, STE 104

PLANNING CONSULTANT SERVICES INC. 2201 E. WILLOW STE. D, # 319

STRUCTURAL ENGINEER: WILLIAM SIMPSON & ASSOCIATES INC. 23 ORCHARD RD., SUITE 250 LAKE FOREST, CA 90405

500 E CARSON PLAZA DR # 201 CARSON CA 90746

TELEPHONE: 949-206-9929

CONTACT: NOFL AQUINO LANDSCAPE ARCHITECT: CWA LANDSCAPE. 950 SANTIAGO AVE

LONG BEACH, CA 90804 CONTACT: CRAIG WEBER ASLA TELEPHONE: 562-494-0411

MEARNS CONSULTING LLC ENVIRONMENTAL CONSULTANTS 738 ASHLAND AVE SANTA MONICA, CA 90405

TELEPHONE: 310-403-1921

METHANE BARRIER ENG: 77 BUNSEN IRVINE CA. 92618 CONTACT: KEVIN LEA TELEPHONE: 949-502-5353

SOIL REPORT: NORCAL ENGINEERING 10641 HUMBOLT STREET LOS ALAMITOS CA 90720

TRACT _ M.B.12-85 16,700±0. (1) 12

10

VICINITY MAP

PLOT PLAN

(3)

SHEET 5

19,210+6

SHEET 4

HEET

122

E. 20TH ST

SHEETS 687

TELEPHONE: (562) 799-9469 JOB: 19872-17 DATED: OCTOBER 10, 2017 M.B. 925-80-81

INDEX OF MODIFIED PRELIMINARY PLANS

DESIGN-BUILT AND DEFERRED SUBTRADE PLANS ARE NOT PART OF THESE PLANS AND ARCHITECT IS DUSTANCE AND BUILDING SUBTRACE FUNDS ARE NOT PART OF THESE PLANS AND ARCHITECT IS NOT LIABLE FOR PERFORMANCE OF HAVE, ELECTRICAL SYSTEMS. OWNER/CONTRACTOR SHALL COORDINATE PLANS WITH UTILITY PROVIDERS AND BUILDING DEPARTMENT.

DEFERRED PERMITS

- SEPARATE PERMITS ARE REQUIRED FOR WORK PERFORMED IN PUBLIC RIGHT OF WAY.
- SEPARATE PERMIT IS REQUIRED FOR AN AUTOMATIC FIRE SPRINKLER SYSTEM
- RFTAINING WALLS AND CMU WALLS UNDER SEPARATE PERMIT. CIVIL ENGINEER AND STRUCTURAL PLANS ARE TO BE SUBMITTED FOR PLAN CHECK AND APPROVAL BEFORE CONSTRUCTION.
- WIRED NETWORKS, DATA CABLE, FIBER OPTICS, SECURITY CAMERAS, ARE NOT PART OF THESE PLANS. METHANE BARRIER PLANS ARE UNDER SEPARATE PERMIT. ENGINEER SHALL SUBMIT PLANS FOR CITY
- PLAN CHECK REVIEW AND APPROVAL REFORE BUILDING PERMIT ISSUANCE
- APPROVAL REQUIRED BY CITY OF SIGNAL HILL ENGINEERING & PUBLIC WORKS DEPARTMENT PRIOR TO SIDEWALK, CURB, STREET, UTILITY AND ANY OTHER OFF-SITE IMPROVEMENTS.
- STRUCTURAL STEEL FABRICATOR SHALL BE CITY OF LOS ANGELES APPROVED LICENSED FABRICATOR
- CONTRACTOR SHALL SLIBMIT A PLAN FOR REVIEW AND APPROVAL OF THE BUILDING OFFICIAL THAT DEMONSTRATES THAT AT LEAST 50% OF THE CONSTRUCTION AND DEMOLITION DEBRIS GENERATED BY THE PROJECT IS RECYCLED/DIVERTED TO COMPLY WITH THE STATE—MANDATED WASTE DIVERSION REQUIREMENTS PURSUANT TO SHIMC 8.08.055 AND CALCREEN SECTIONS 4.408 AND 5.408. A CONTRACTOR PRODUCING CONSTRUCTION AND DEMOLITION DEBRIS SHALL EITHER CONTRACT WITH THE CITY'S REFUSE CONTRACTOR FOR THE REMOVAL OF THE DEBRIS, OR SELF—HAUL THE DEBRIS TO A DISPOSAL SITE CERTIFIED BY THE LOS ANGELES COUNTY SANITATION DEPARTMENT. PRIOR TO RECEIVING DISPOSAL SITE CERTIFIED BY THE LOS ANGELES COUNTY SANITATION DEPARTMENT. PRIOR TO RECEIVING A PERMIT FROM THE CITY FOR CONSTRUCTION OR DEMOLITION, THE CONTRACTOR SHALL DEVELOP AND SUBMIT A PLAN TO RECYCLE AND SALVAGE THE PROJECTED CONSTRUCTION AND DEMOLITION DEBRIS TO THE GREATEST EXTENT FEASIBLE. THE RECYCLING PLAN MAY INCLUDE SOURCE-SEPARATED RECYCLING, MIXED DEBRIS RECYCLING, SALVAGING AND DISPOSAL OF NON-RECYCLABLES AND NON-SALVAGEABLE DEBRIS. THE CONSTRUCTION AND DEMOLITION DEBRIS RECYCLING PLAN CERTIFICATION MUST BE COMPLETED AND SUBMITTED ALONG WITH PLANS. WASTE HANDLING RECEIPTS MUST OBTAINED FOR ALL DEBRIS REMOVAL WHETHER DELIVERED TO EDCO OR ANOTHER CERTIFIED WASTE DIVERSION/DISPOSAL FACILITY. FAILURE TO COMPLY WITH THE APPROVED PLAN MAY RESULT IN ASSESSMENT OF PENALTIES IN ADDITION TO PERMIT FEES.
- 10. SEPARATE PERMITS REQUIRED FOR SOLAR PANELS.

SITE PLANS TO TITLE SHEET, VICINITY MAP, PROJECT TITLE PRELIMINARY SITE PLAN SITE PLAN SECTIONS FIRE DEPARTMENT ACCESS PLAN SITE DETAILS SECTIONS

SITE SECTIONS
TRASH COLLECTION SITE PLAN VIEW STUDY SITE PLAN VIEW STUDY SECTIONS

HOME A A1.1 A1.2

HOUSE A SECTIONS B.

HOUSE A ROOF PLAN HOUSE A ELEVATIONS
HOUSE A ELEVATIONS
HOUSE A SECTIONS A, D

EMPLE

PROJECT

SITE

60

NARSIMHA REDDY 123 ATLANTIC AVE

PRE-CONSTRUCTION ADJACENT SITES ASSESSMENT

- OWNER/BUILDER SHALL RETAIN A THIRD PARTY CONSULTANT/INSPECTOR TO PROVIDE ADJACENT PROPERTIES REPORTS TO DOCUMENT THE PRE-EXISTING CONDITIONS AND DAMAGES OF THE REATINING WALLS AND HARDSCAPE.
- . MEASUREMENTS OF ALL EXISTING DAMAGES OBSERVED, INCLUDING CRACK LENGHTS, WIDTHS AND AND PRECISE LOCATION
- . PHOTOGRAPHS SHOULD BE TAKEN TO ACCOMPANY WRITTEN NOTES THAT REFER TO DAMAGES OR EVEN LACK OF
- 4. FLOOR LEVEL SURVEY OF NEARBY STRUCTURES SHALL BE CONSIDERED ESPECIALLY IF PRE-EXISTING DAMAGE IS EVIDENT.
- IT IS RECOMMENDED THAT PROJECT GEOLOGIST/SOIL ENGINEER BE ON-SITE DURING EXCAVATION TO EVALUATE THE CONDITIONS AS THE PROJECT ADVANCES. 6. IT IS RECOMMENDED THAT CONTRACTOR USES EXPERIENCE EXCAVATION EQUIPMENT OPERATORS TO MINIMIZE VIBRATION AND NOISE AND ELIMINATE STRUCTURAL DAMAGE IN THE VICINITY OF WORK.

HOUSE "A" MODIFICATIONS - PRELIMINARY PLANS

Signal Hill, CA 90755 657-203-1583

OCS BOZENA JAWORSK ARCHITECT EXPRESSLY RESERVE TS COMMON LAW COPYRIGHT AND OTHER PROPERTY RIGHTS A

PROJECT #4921

REVISIONS

02-01-2024 CLIENT REVIEW MODIF. DUE TO WELL DISCOVE 4-18-25 SUBMIT MODIFIED

5-2-25 PLANNING RELEASE F

SITE ADDRESS

2750 F 20TH ST SIGNAL HILL, CA. 90755

OWNER


ONG BEACH, CA.90802


TITLE SHEET

SHEET TITLE

T01

C:\01 Recent Jobs\000 DCS\4917A House A Modified\House A Modif Site Plans 2.DWG, 5/4/2025 9:33:02 PM, DWG To PDF.pc3

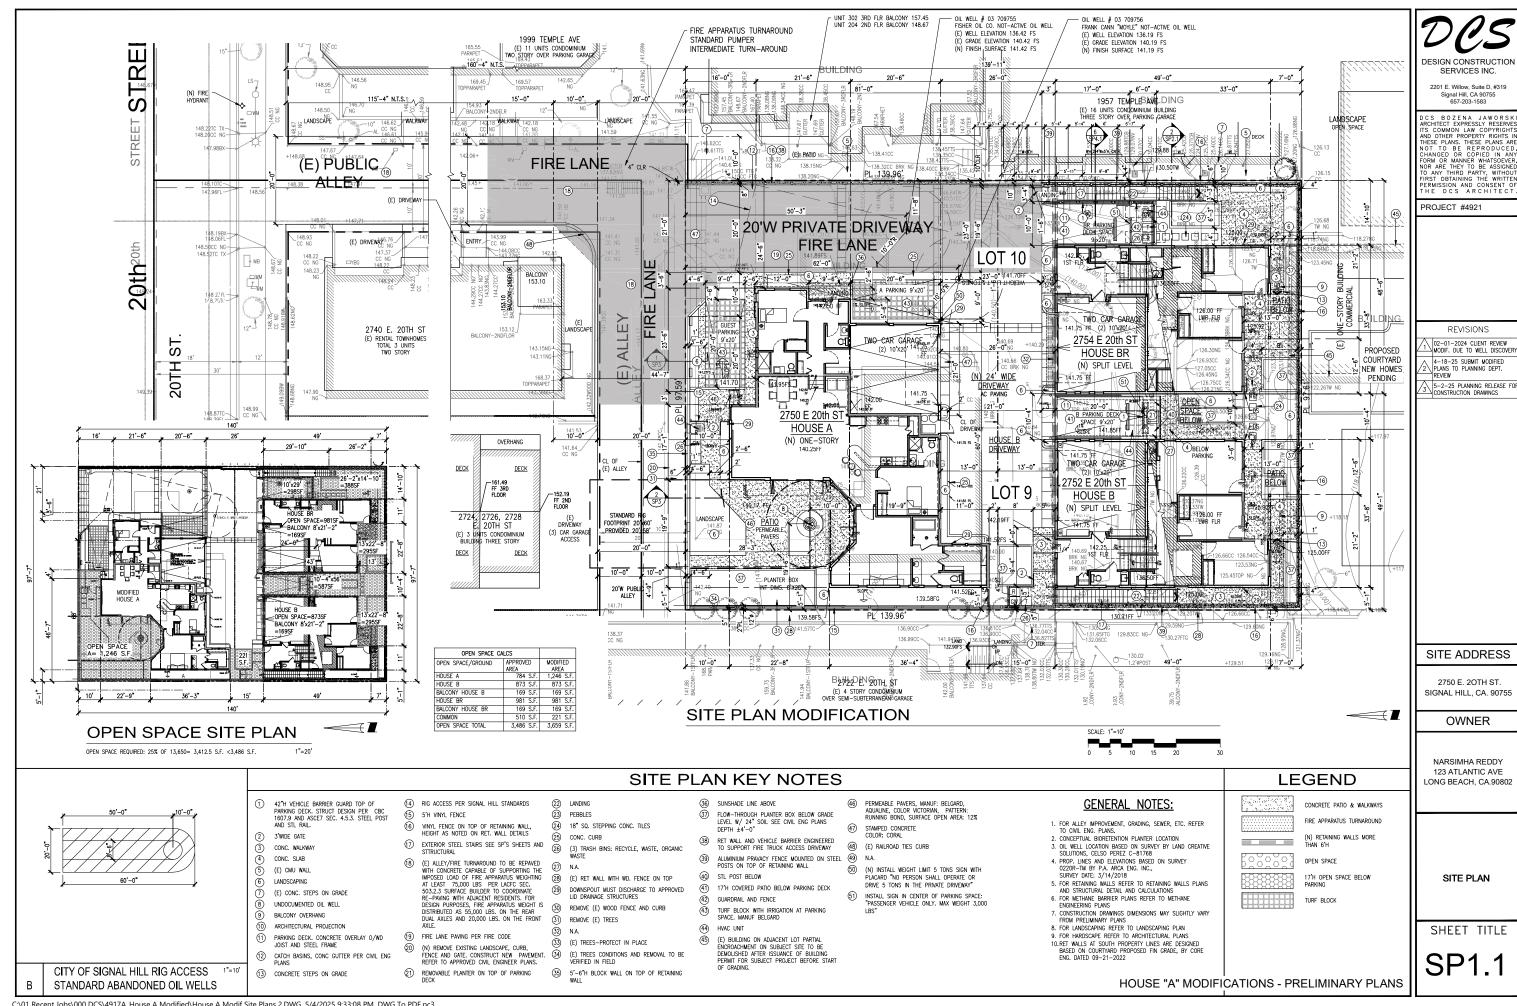

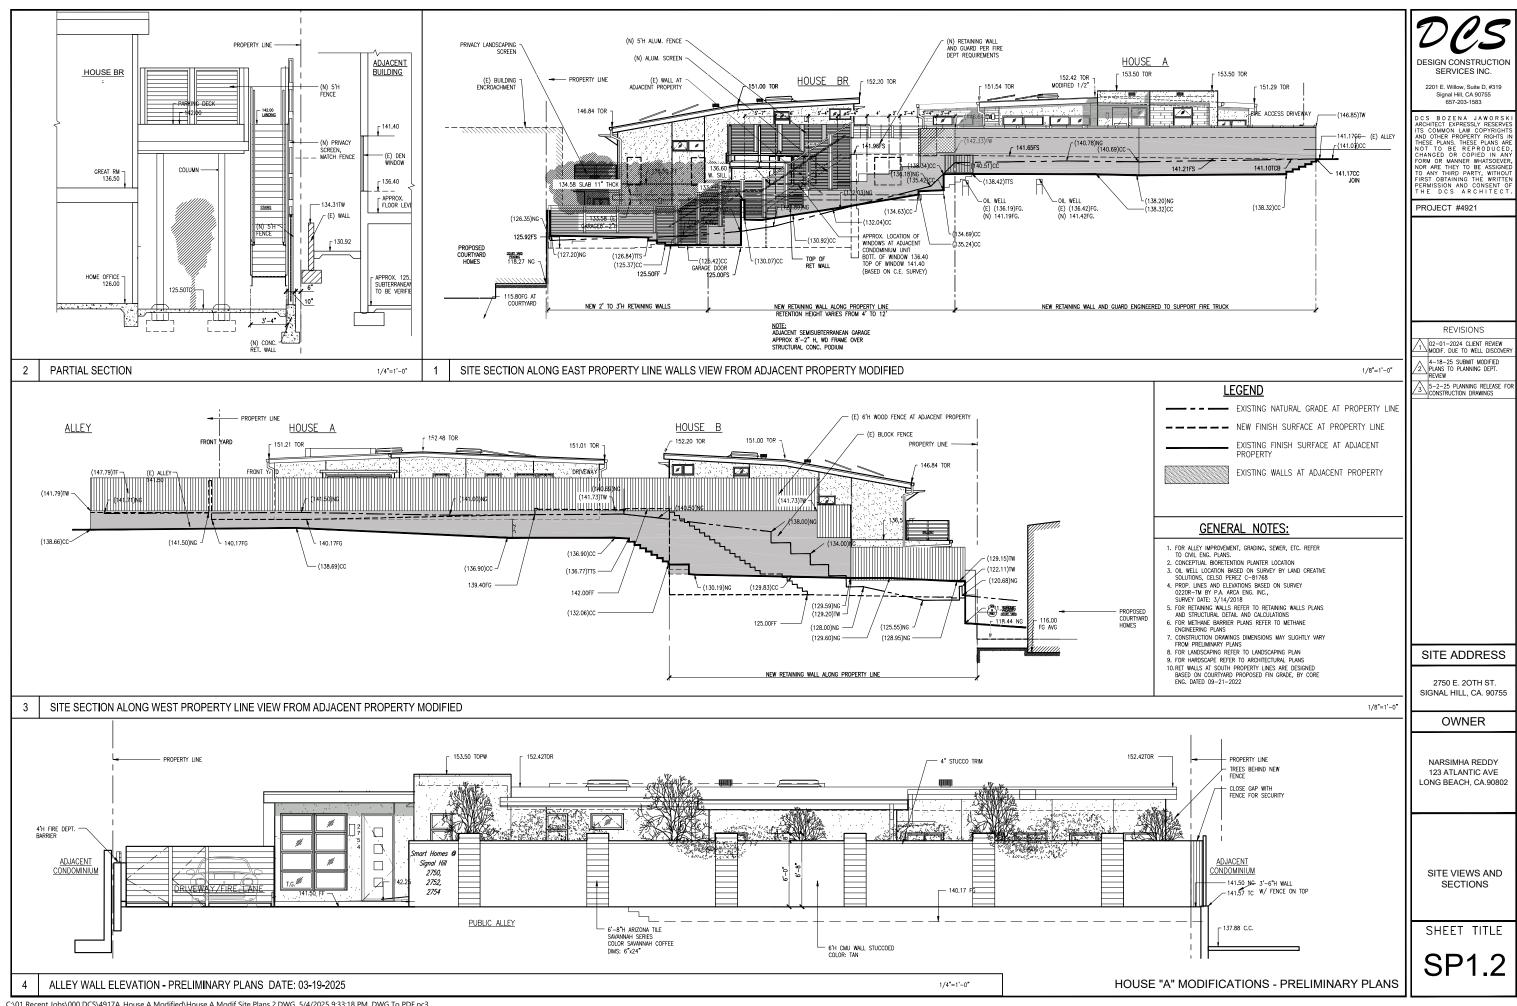

BUILDING CODE DATA

PROPOSED NEW CONSTRUCTION: THREE DETACHED CONDOMINIUM HOMES,

TYPE OF CONSTRUCTION: V-B FULLY, SPRINKLERED CRC 2019

OCCUPANCY GROUP R DIVISION 3

	BUILDING AREA		MODIFI	IED
HOUSE	LIVING	GARAGE	LIVING	GARAGE
A	2,010 S.F.	489 S.F.	1,961 S.F.	437 S.F
В	2,317 S.F.	456 S.F.	2,317 S.F.	456 S.F
BR	2,317 S.F.	456 S.F.	2,317 S.F.	456 S.F
TOTAL	6,644 S.F.	1,401 S.F.	6,595 S.F.	1,349 S.F

FIRE DEPARTMENT NOTES

- EXTERIOR DOORS AND OPENINGS REQUIRED BY THIS CODE OR CBC SHALL BE MAINTAINED READILY ACCESSIBLE FOR EMERGENCY ACCESS.
- MAINIANED READILY ACCESSIBLE FOR EMERGENCY ACCESS.


 2. APPROVED BUILDING ADDRESS NUMBERS, BUILDING NUMBERS OR APPROVED BUILDING DENIFICATION SHALL BE PROVIDED AND MANTAINED SO AS TO BE PLAINLY WISBLE AND LEGIBLE FROM THE STREET FRONTING THE PROPERTY. THE NUMBERS SHALL CONTRACT WITH THEIR BACKGROUND, BE ARABIC NUMBERALS OR ALPHABET LETTERS, AND BE A MINIMUM OF 4 INCHES HIGH WITH A MINIMUM STROKE WIDTH OF 0.5 INCH. FIRE CODE 505.1
- STROKE WIGHT OF 0.5 INCH. FIRE COUR SOUR


 3. AT LEAST ONE EGRESS DOOR SHALL BE PROVIDED FOR EACH DWELLING UNIT, THE
 EGRESS DOOR SHALL BE SIDE-HINGED, AND SHALL PROVIDE A MINIMUM CLEAR
 WIDTH OF 32 INCHES WHEN MEASURED BETWEEN THE FACE OF THE DOOR AND
 THE STOP. THE MINIMUM CLEAR HEIGHT OF THE DOOR SHALL NOT BE LESS THAN
 78 INCHES IN HEIGHT MEASURED FROM THE TOP OF THE THRESHOLD TO THE
 BOTTOM OF THE STOP. EGRESS DOORS SHALL BE READLY OPENABLE FROM INSIDE
 THE DWELLING WITHOUT THE USE OF A KEY OR SPECIAL KNOWLEDGE OR EFFORT.
 RESIDENTIAL CODE R311.2
- SMOKE ALARMS SHALL BE INSTALLED IN THE FOLLOWING LOCATIONS:
 I. IN EACH SLEEPING ROOM.
 - 2. OUTSIDE EACH SEPARATE SLEEPING AREA IN THE IMMEDIATE VICINITY OF THE BEDROOMS.
- BEDROOMS.

 3. ON EACH ADDITIONAL STORY OF THE DWELLING, INCLUDING BASEMENTS AND HABITABLE ATTICS BUT NOT INCLUDING CRAWL SPACES AND UNINHABITABLE ATTICS. IN DWELLINGS OR DWELLING UNITS WITH SPLIT LEVELS AND WITHOUT AN INTERVENING DOOR BETWEEN THE ADJACENT LEVELS, A SMOKE ALARM INSTALLED ON THE UPPER LEVEL SHALL SUFFICE FOR THE ADJACENT LOWER LEVEL PROVIDED THAT THE LOWER LEVEL IS LESS THAN ONE FULL STORY BELOW THE UPPER LEVEL. WHEN MORE THAN ONE SMOKE ALARM IS REQUIRED TO BE INSTALLED WITHIN AN INDIVIDUAL DWELLING UNIT THE ALARM BEOCKES SHALL BE INTERCONNECTED IN SUCH A MANNER THAT THE ACTUATION OF ONE ALARM WILL ACTIVATE ALL OF THE ALARMS IN THE INDIVIDUAL UNIT, RESIDENTIAL CODE R314.3
- CARBON MONOXIDE ALARM: SINGLE- AND MULTIPLE- STATION CARBON MONOXIDE ALARMS SHALL BE LISTED AS COMPLYING WITH THE REQUIREMENTS OF UL 2034. CARBON MONOXIDE DETECTORS SHALL BE LISTED AS COMPLYING WITH THE REQUIREMENTS OF UL 2075. CARBON MONOXIDE ALARMS REQUIRED BY (SECTIONS R315.1 AND R315.2) OR (SECTIONS 420.4.1 AND 420.4.2)
- SHALL BE INSTALLED IN THE FOLLOWING LOCATIONS:

 1. OUTSIDE OF EACH SEPARATE DWELLING UNIT SLEEPING AREA IN THE IMMEDIATE VICINITY OF THE BEDROOM(S).
- 2. ON EVERY LEVEL OF A DWELLING UNIT INCLUDING BASEMENTS.

 3. FOR R-1 ONLY, A. ON THE CEILING OF SLEEPING UNITS WITH PERMANENTLY INSTALLED FUEL-BURNING APPLIANCES. RESIDENTIAL CODE R315.3, BUILDING CODE
- CARBON MONOXIDE ALARM SHALL BE INTER-CONNECTED, HARDWIRE WITH BATTERY BACKUP.
- FIRE SPRINKLER PLANS SHALL BE SUBMITTED TO THE LA COUNTY FIRE DEPARTMENT FIRE SPRINKLER PLAN CHECK UNIT FOR REVIEW AND APPROVAL PRIOR TO INSTALLATION IN ACCORDANCE WITH FIRE CODE 901.2.

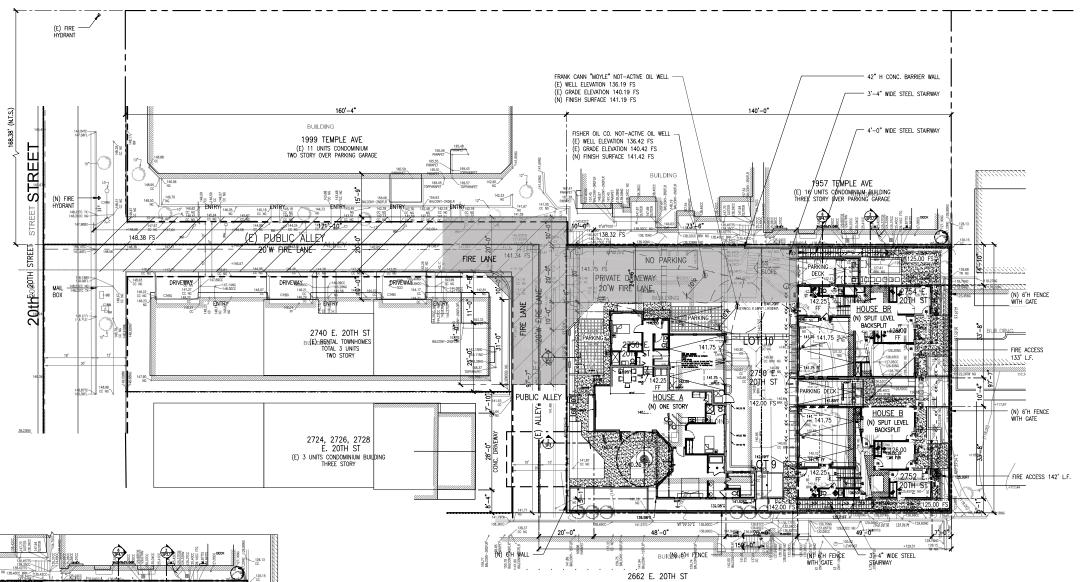

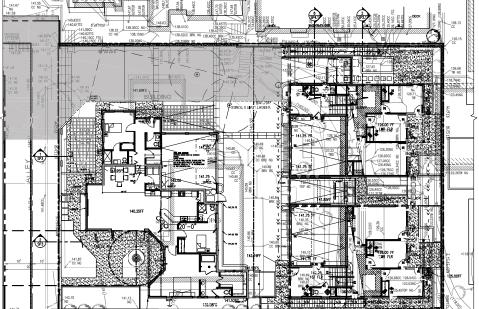


FIRE APPARATUS ACCESS ROAD ALTERNATIVE TO HAMMERHEAD

LA COUNTY FIRE DEPARTMENT ACCESS. ALTERNATIVE TO HAMMERHEAD

1/16"=1'-0"

FIRE DEPARTMENT ACCESS SITE PLAN -

MODIFIED TURN-AROUND APPROVED BY JANNA MASI, LA COUNTY FIRE PREVENTION DIVISION, LAND DEVELOPMENT UNIT. DATE NOVEMBER 9, 2017.

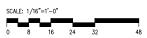


NOTES:

- 1. LOT 9 & 10 TO BE MERGED FOR CONDOMINIUM SUBDIVISION
- OIL WELLS NOT ACTIVE, APPROX. 5' BELOW PROPOSED PAVING.
 ACCESS TO OIL WELLS PROVIDED IN COMPLIANCE WITH CITY OF SIGNAL HILL STANDARDS.
- 4. METHANE TEST OF OIL WELLS: BY MEARNS CONSULTING LLC, DATED NOV. 30, 2016.
- 5. OIL WELL "MOYLE" APR 037-09566 REPORT OF ABANDONMENT DATED JANUARY 25, 1951.
- 6. OIL WELL "FISHEROIL" APR 037-09755 REPORT OF ABANDONMENT DATED APRIL 27, 1927.
- 7. NEW FIRE HYDRANT TO BE INSTALLED PER LA COUNTY FIRE CODE REGULATIONS.

 8. (E) 20' WIDE ALLEY IS TO BE RESURFACED TO SUPPORT 75,000 LBS LOAD OF FIRE TRUCK.
- (E) EXISTING TO REMAIN OR PROPOSED GATES SHALL BE EQUIPPED WITH A FIRE DEPARTMENT APPROVED LOCKING DEVICE.
- 10. A DIGITAL COPY OF THE FINAL MAP SHALL BE SUBMITTED TO THE FIRE DEPARTMENT'S LAND DEVELOPMENT UNIT FOR REVIEW AND APPROVAL PRIOR TO RECORDATION. SUBMITTAL SHALL BE PROVIDED THROUGH EPIC-LA USING FOLLOWING PLAN TYPE: FIRE LAND DEVELOPMENT-CITY REQUEST-FINAL MAP (TRACK/PARCEL)

VICINITY MAP OIL WELLS

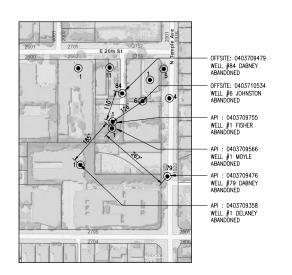

HOUSE "A" MODIFICATIONS - PRELIMINARY PLANS

SITE ADDRESS

DESIGN CONSTRUCTION

SERVICES INC.

2201 F Willow Suite D #319

CS BOZENA JAWORSK ARCHITECT EXPRESSLY RESERVE

ARCHITECT EXPRESSLY RESERVES
ITS COMMON LAW COPYRICHTS
AND OTHER PROPERTY RIGHTS IN
HIESE PLANS. HESE PLANS ARE
NOT TO BE REFORDUCED
CHANGED OR COPIED IN ANY
FORM OR MANNER WHATSOEVER
TO ARE THEY TO BE ASSIGNED
TO ARE THEY TO BE ASSIGNED
TO ARE THEY TO BE ASSIGNED
THEY THEN THE WITHOUT
THE DOS A RICHITECT
THEY DOS A RICHITECT

REVISIONS

02-01-2024 CLIENT REVIEW
MODIF. DUE TO WELL DISCOVER
4-18-25 SUBMIT MODIFIED
PLANS TO PLANNING DEPT.
REVIEW

5-2-25 PLANNING RELEASE FO

PROJECT #4921

2750 E. 20TH ST. SIGNAL HILL, CA. 90755


OWNER


NARSIMHA REDDY 123 ATLANTIC AVE LONG BEACH, CA.90802


FIRE DEPT. ACCESS SITE PLAN

SHEET TITLE

SP2

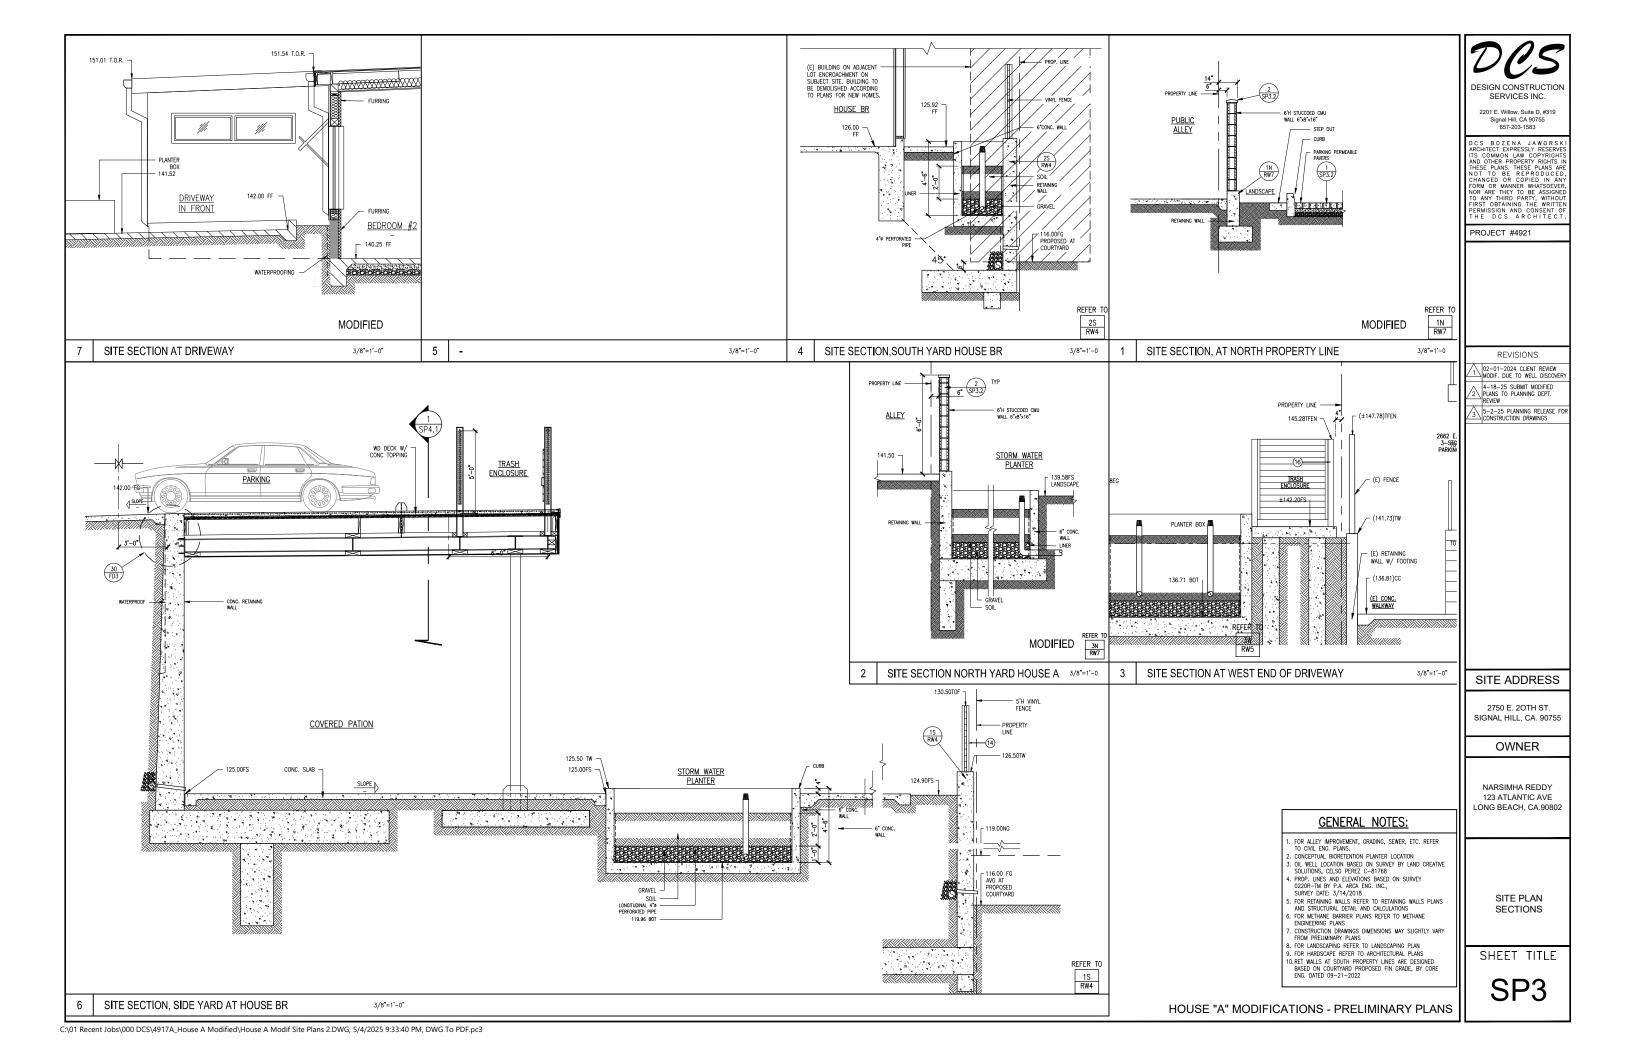

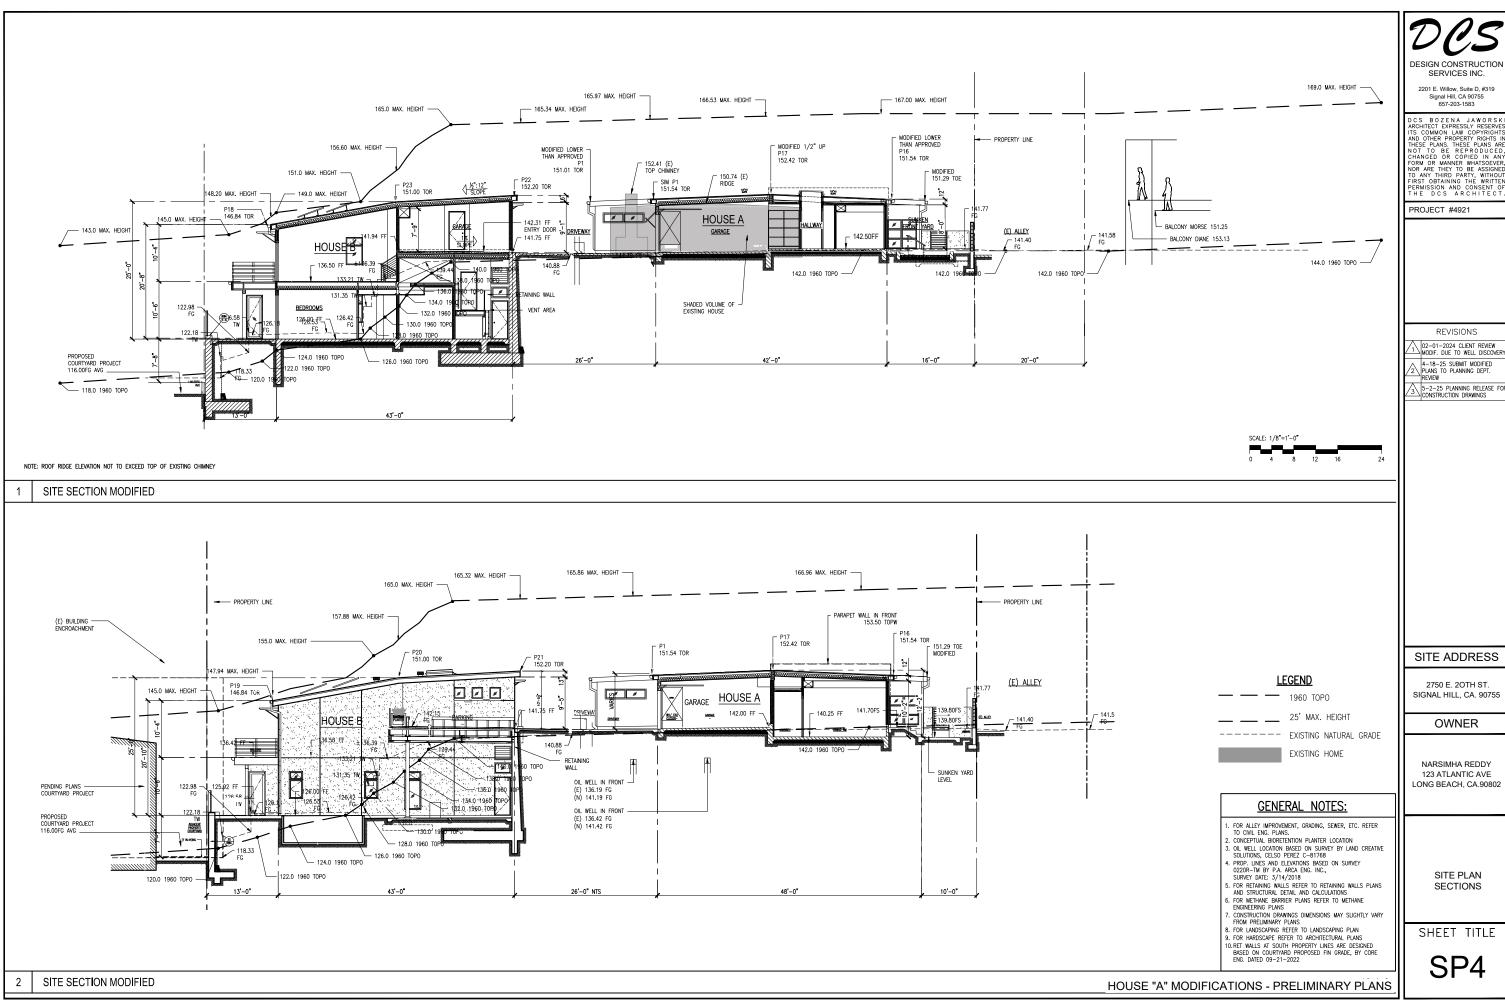

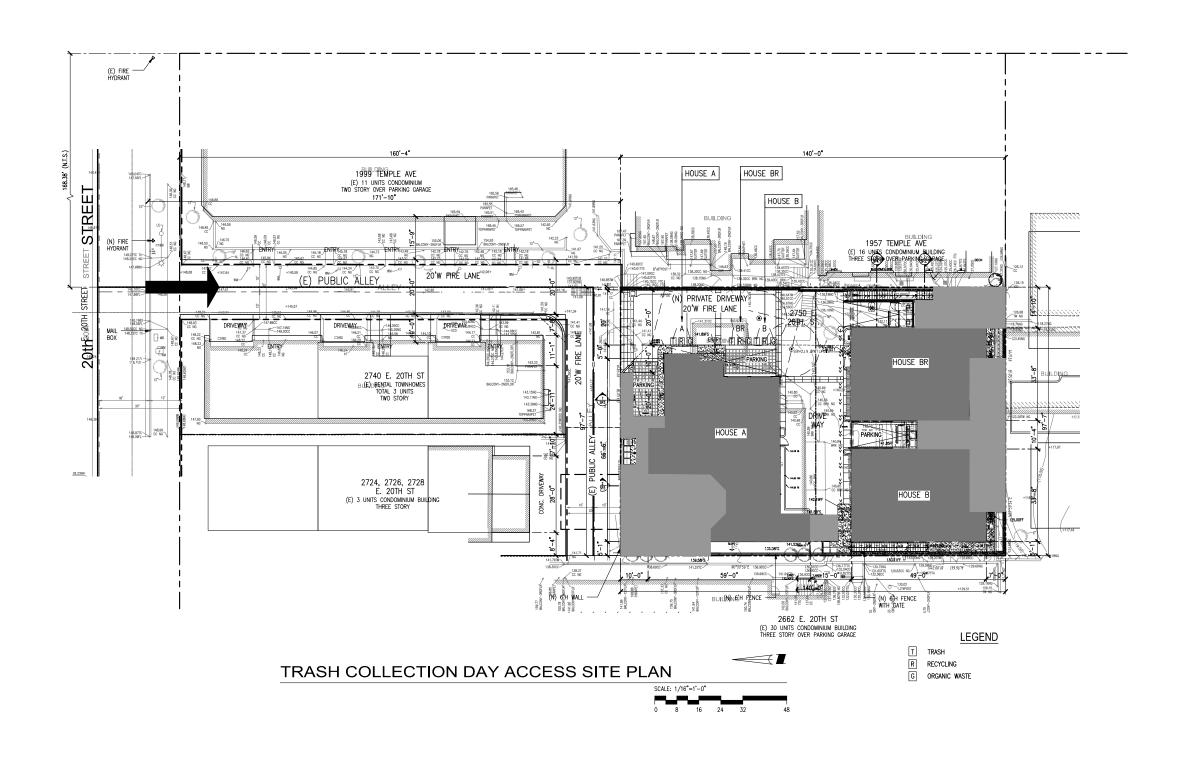

DESIGN CONSTRUCTION SERVICES INC.

DCS BOZENA JAWORSK ARCHITECT EXPRESSLY RESERVES ITS COMMON LAW COPYRICHTS AND OTHER PROPERTY RIGHTS IN THESSE PLANS ARE NOT TO BE REPRODUCED, CHANGED OR COPIED IN ANY FORM OR MANNER WHATSOEVER, TO ANY THIED PARTY, WITHOUT FIRST OBTAINING THE WRITED PERMISSION AND CONSENT OF THE DCS ARCHITECT

PROJECT #4921

REVISIONS

02-01-2024 CLIENT REVIEW MODIF. DUE TO WELL DISCOVER

4-18-25 SUBMIT MODIFIED
PLANS TO PLANNING DEPT.
REVIEW

3 5-2-25 PLANNING RELEASE FOR

SITE ADDRESS

2750 E. 20TH ST. SIGNAL HILL, CA. 90755

OWNER


NARSIMHA REDDY 123 ATLANTIC AVE LONG BEACH, CA.90802

TRASH COLLECTION SITE PLAN

SHEET TITLE

SP5

POLE NUMBER	APPROVED. TOP POLE ELEV.	ORIGINALLY REVISED POLE ELEV	MODIFIED POLE ELEV.	
P1	151.54	152.42	MODIFIED LOWER THAN APPROVED	
P2			OMIT	
P3			OMIT	
P4			OMIT	
P5			OMIT	
P6			OMIT	
P7			OMIT	
P8	151.54		SAME	
P9	152.38	152.42	MODIFIED 1/2" UP	
P10	153.50		SAME	
P11	153.50		SAME	
P12	153.50		SAME	
P13	153.50		SAME	
P14		151.29	MODIFIED LOWER THAN APPROVED	
P15		151.29	MODIFIED LOWER THAN APPROVED	
P16	151.54	152.16	SAME SLOPE ROOF CUT BACK	
P17	152.38	152.42	MODIFIED 1/2" UP	
P18	146.84			
P19	146.84			
P20	151.00			
P21	152.20			
P22	152.20			
P23	151.00			
P24	146.84			
P25	146.84			
P26	151.00			
P27	152.20			
P28	152.20			
P29	151.00			

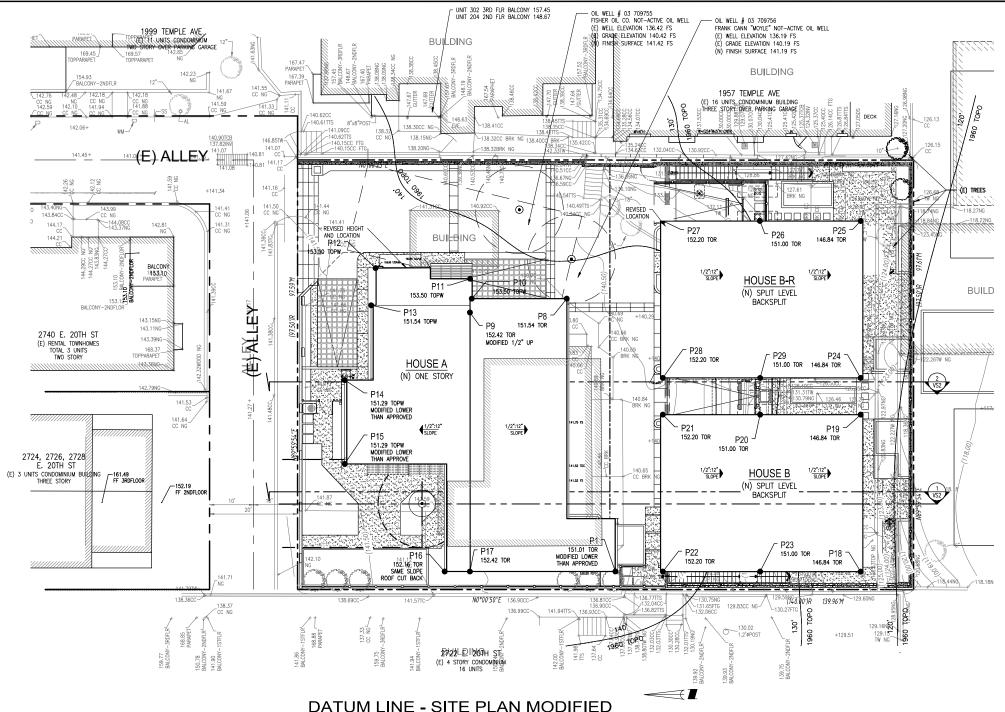

ABBREVIATIONS

PROP. ELEV. TOR TOPW ELEVATION TOP OF ROOF TOP OF PARAPET WALL

DATUM LINE - SITE PLAN MODIFIED

1 STORY POLES TO BE STRIPED IN 6" INCREMENTS. TOTAL 4 INCREMENTS

NOTES:

- RECORD VIEW ANALYSIS DRAWINGS.
 CURRENT REVISION: ADD PARKING SPACE DOES NOT CHANGE THE ROOF ELEVATIONS, NOR LOCATION OF HOUSES.
- 3. HOUSE A BASEMENT WAS ELIMINATED

DATUM LINE SITE PLAN

SHEET TITLE

DESIGN CONSTRUCTION SERVICES INC.

2201 E. Willow, Suite D, #319 Signal Hill, CA 90755 657-203-1583

DCS BOZENA JAWORSK ARCHITECT EXPRESSLY RESERVE ITS COMMON LAW COPYRIGHT AND OTHER PROPERTY RIGHTS I HESS PLANS. THESE PLANS AR NOT TO BE REPRODUCEL CHANGED OR COPIED IN AN FORM OR MANNER WHATSOLVE TO ANY THEO PARTY, STH

REVISIONS

02-01-2024 CLIENT REVIEW MODIF. DUE TO WELL DISCOVE

4-18-25 SUBMIT MODIFIED PLANS TO PLANNING DEPT. REVIEW

5-2-25 PLANNING RELEASE FO

SITE ADDRESS

2750 E. 20TH ST.


SIGNAL HILL, CA. 90755


OWNER

NARSIMHA REDDY 123 ATLANTIC AVE LONG BEACH, CA.90802

PROJECT #4921

VS1

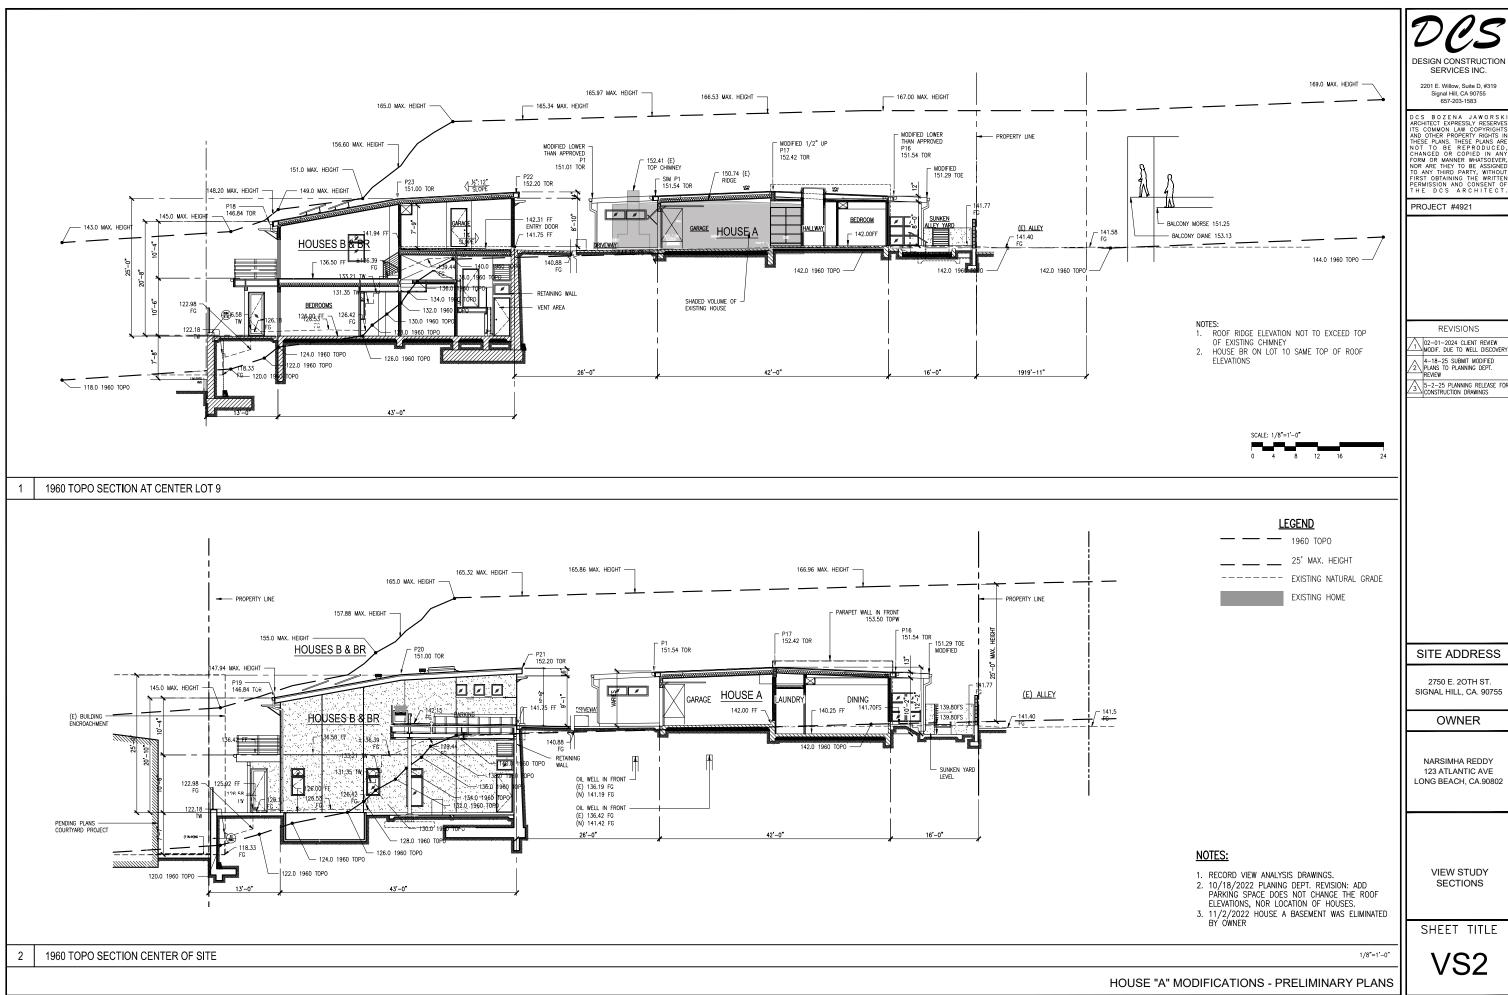

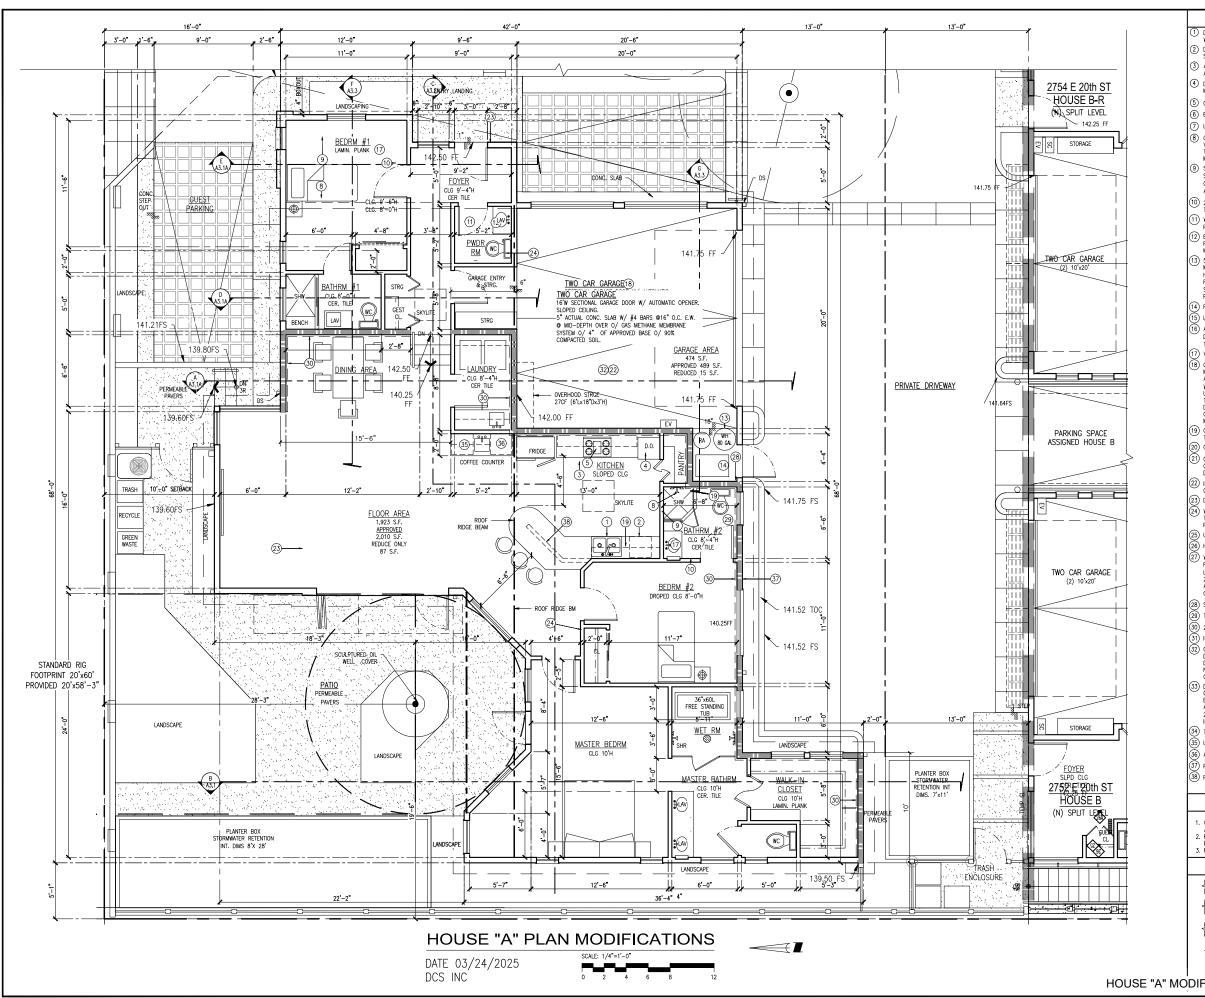

PLAN KEY NOTES

- DOUBLE SINK WITH 1/2 HP. GARBAGE DISPOSAL (BADGER OR EQUAL)
 WITH AIR GAP FOR DISHWASHER UNDER COUNTER INSTALLATION.
- DISHWASHER WITH AIR GAP VERIFY DIMENSIONS WITH MANUFACTURES SPECIFICATIONS.
- 3 48" CLEAR REFRIGERATOR SPACE PROVIDE RECESSED COLD WATER BIBB AND SHUT OFF FOR ICE MAKER.
- 4 DOUBLE OVEN CONSISTING OF (1) CONVECTION OVEN AND (1) MICROWAVE OVEN WITH VENT HOOD.
- (5) COOKTOP AND VENT (HOOD OPTIONAL)
- (6) BAR SINK
- (7) LAUNDRY SINK
- CONTROL VALVES TO BE PRESSURE BALANCED OR THERMOSTATIC MIXING VALVES PER C.P.C. 420.0. PACK ALL TUB VOIDS WITH INSULATION WHEN TUBS OCCUR ADJACENT PARTY WALLS, VERIFY UNIT DIMENSIONS WT. MANUFACTURER PRIOR TO FRAMING.
- SHOWER WALLS MUST BE FINISHED WITH A SMOOTH, NON ABSORBENT SURFACE TO A MIN HEIGHT OF 72" ABOVE FLOOR PER CBC R307.2. GLASS ENCLOSURE DOORS & PANELS MUST BE 1/8" FULLY TEMPD. ATTACH TOWEL BAR TO DOOR. SEE NOTE #29
- 10) 2x6 FLAT BLOCKING AT +40" ABOVE FINISHED FLOOR FOR 24" WIDE TOWEL BAR.
- WASHER SPACE, PROVIDE RECESSED WATER AND DRAIN CONNECTIONS, PROVIDE "SMITTY" PAN AND DRAIN AT SECOND FLOOR LOCATIONS.
- 2) ELECTRIC HEAT PUMP CLOTHES DRYER, PROVIDE 30 AMP CIRCUIT.
 PROVIDE DRAIN NOT VENT NOT REQUIRED. INSTALL IN COMPLIANCE WITH
 MANUFACTURER REQUIREMENTS.
- (13) 50 GAL WATER HEATER, MANUF.: RHEEM
 MD: PROTERRA, HYBRID HEAT PUMP,
 HIGH EFFICIENCY SMART TANK WYLEAK DETECTION & AUTO SHUT— OFF
 PROVIDE FLEX CONNECTORS AND SEISMIC STRAPS PER DET. HEATER SET ON 18" HIGH PLATFORM WHEN LOCATED IN GARAGE OR LAUNDRY ROOM PER C.P.C. TABLE 5-1 COL 2 No, 3. REFER TO PLUMBING PLAN (4) F.A.U. INSTALL PER C.B.C. REQUIREMENTS, PROVIDE SEISMIC BRACES
- 5) LAVATORY TOP OF COUNTER INSTALLATION
- 6) A.C. CONDENSER ON CONC SLAB, PROVIDE 220V WEATHERPROOF DISCONNECT AND 110V WEATHERPROOF OUTLET WITHIN 25' FROM UNIT. TOP OF CONC. SLAB MIN. 3" ABOVE GROUND PER C.M.C.
- VITREOUS CHINA LAVATORY, UNDER COUNTER INSTALLATION
- 18) GARAGE DOOR WITH AUTOMATIC DOOR OPENER
 MANUFACTURER: LIFT MASTER OR EQUAL, IN COMPLIANCE WITH UL 325
 AND NEMA ICS-6.
- AND NEMA ICS-6.

 WARRANTY: 5 YEARS. MIN ¾ HP WITH EDGE SENSOR.

 UL 325 REQUIRES A DOOR STARTING FROM PARTIALLY OPEN POSITION
 TO STOP AND THAN RAISE A MIN. OF 2 INCHES WHEN OBSTRUCTION I TO STOP AND THAN RAISE A MIN. OF 2 INCHES WHEN OBSTRUCTION DETECTED.

 CONTRACTOR TO INSTALL AND TEST DOOR OPENER ACCORDING TO MANUFACTURER INSTRUCTIONS.
- (19) GYP. BD, DROPPED SOFFITS FOR HVAC DUCTS. FRAMING CONTRACTOR TO COORDINATE WIDTH WITH HVAC CONTRACTOR. 20) GYP. BD, DECORATIVE SOFFITS
- 21) GYP.BD. DROP'D SOFFIT AT INTERIOR TO BE PROVIDED BY FRAMING CONTRACTOR WHEN REQUIRED BY HVAC CONTRACTOR OR INTERIOR DECORATOR
- (22) INSTALL 5/8" TYPE "X" GYP. BD. AT GARAGE WALLS AND CEILING. COMMON WITH HABITABLE ROOMS.
- 23) DROP CONC. SLAB AS APPLICABLE FOR PAVERS
- 24) WALL STUD SIZE INDICATED IN KEYNOTES AND ON PLAN ARE PROVIDED TO SET WALL WIDTH, SEE STRUCTURAL PLANS FOR ACTUAL STUD & POST REQUIREMENTS.
- 25) UNDER COUNTER COOLER
- HVAC DUCTS WALL OPENINGS
- WALKING DECK. MANUF: WESTCOAT OR EQUAL (800)250-4519. INSTALL POLYMER MODIFIED CEMENTITOUS DECK OVER HOT DIP GAL. METAL LATH, 0/ 1-1/8" EXT GRADE PLYWOOD. MIN SLOPE 1/1:10 39E. MILLIA 2201. APPLY CUSTOM FINISH AS SELECTED BY OWNER. INSTALL IN ACCORDANCE TO MANUFACTURERS SPECIFICATIONS AND APPLICABLE CODES. (HOUSE B & BR)
- 28) SOLAR CONTROLS
-) TOILET
- 30) 2" FURRING
- INSTALL SECURITY SYSTEM PER OWNER SPECIFICATIONS
- C.B.C. SEC. R302.5.2 DUCT PENETRATION. DUCTS IN THE GARAGE AND DUCTS PENETRATING THE WALLS OR CEILINGS SEPARATING THE DWELLING FROM THE GARAGE SHALL BE CONSTRUCTED OF A MINIMUM No.26 GAGE SHEET STEEL AND SHALL HAVE NO OPENINGS IN TO THE
- DUMBWAITER, MANUFACTURER: POWERLIFT DUMBWAITERS CORPORATION OR EQUAL MODEL: POWERLIFT 100 RESIDENTIAL OR EQ. UL CERTIFIED ELEVATOR CONTROLLER, DOOR LOCKS WITH DOOR SWITCHES, AND ACCESS DOOR SAFETY SWITCH, 150 LBS. CAPACITY. CAR SIZE 24"4"x30" HIGH. INSTALL IN COMPLIANCE WITH MANUFACTURER'S INSTRUCTION.
- 34) TILE VENEER. SEE SHT. DO2/ DET. 13
- UNDERCOUNTER BEVERAGE COOLER
- 36) APPLIANCE GARAGE
- RET WALL, EXTEND 8" ABOVE PLANTER CURB
- (38) PONY WALL

GENERAL NOTES

- . CONC. SLAB TO BE 3" RECESSED IN BATHROOMS, LAUNDRY & KITCHEN AREAS
- AREAS.

 2. REFER TO PLUMBING, MECHANICAL AND ELECTRICAL PLANS FOR
- FIXTURES AND EQUIPMENT.

 3. REFER TO STRUCTURAL PLANS FOR STRUCTURAL ENGINEERING.

LEGEND



STEM WALL & FURRING

HOUSE "A" MODIFICATIONS - PRELIMINARY PLANS

DESIGN CONSTRUCTION SERVICES INC.

2201 F Willow Suite D #319 Signal Hill, CA 90755 657-203-1583

PROJECT #4921

REVISIONS

02-01-2024 CLIENT REVIEW MODIF. DUE TO WELL DISCOVER

4-18-25 SUBMIT MODIFIED PLANS TO PLANNING DEPT. REVIEW

5-2-25 PLANNING RELEASE FO

SITE ADDRESS


2750 E. 20TH ST. SIGNAL HILL, CA. 90755

OWNER

NARSIMHA REDDY 123 ATLANTIC AVE LONG BEACH, CA.90802

HOUSE A 1ST FLOOR PLAN

SHEET TITLE **HOUSE A**

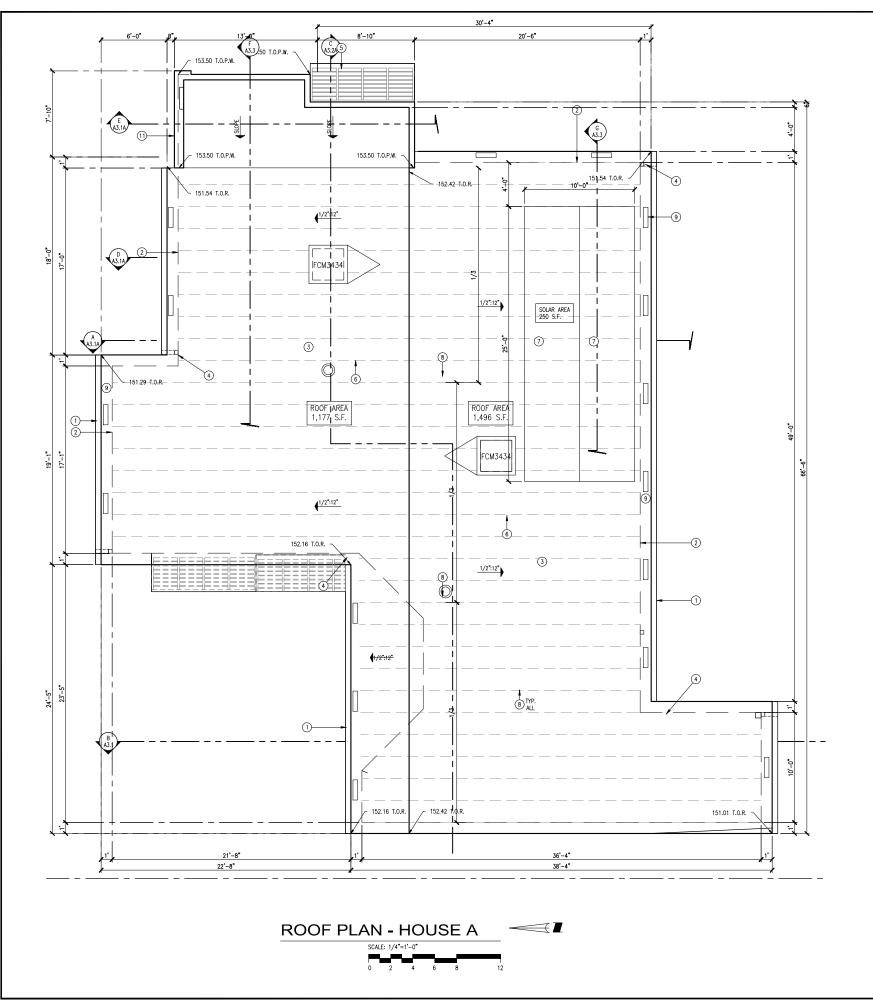

ROOF PLAN KEY NOTES

- 1 GUTTER
- 2 WALL BELLOW

3 SINGLE PLY ROOF COVERING SYSTEM CLASS B
MANUF: SARNAFIL OR EQUAL
O/ 80 MIL SARNAFIL 6410 FELTBACK ENERGY SMART GLASS—FIBER REINFORCED PVC
ROOF MEMBRANK ADMICTATION FOR THIS WITH SARNACOL 2121 WATER—BASED
ADHESINE O/ (1) LAYER OF ½" THICK DENSDECK O/ COMBUSTIBLE ROOF SHEATHING
OLD TAM

COLOR: TAN (1) CALER OF 2 THICK DENSITIES OF COMBUSTIBLE ROOF SHEARING COLOR: TAN MIN. SLOPE X*:12" (2%)
WEIGHT: 0.552 PSF
INSTALLED BY MANUFACTURER TRAINED AND APPROVED ROOFER.
WARRANTY, SYSTEM 30 YRS,
INSTALLATION MUST COMPLY WITH MANUFACTURER'S INSTRUCTION THE REPORT &

APPLIANCE CODE
APPROVAL REPORT: ESR1157 -RENEWAL DATE 09-2017

BARRIER BOARD:
%" THCK DENSDECK PRIME ROOF BOARD

72 INFO DEVISION FINISH TOUR DOWNLO MANUFACTURER: GEORGIA PACIFIC MECHANICALLY FASTENED TO ROOF SHEATHING ROOFING CONTRACTOR SHALL SUBMIT EVIDENCE OF APPROVAL, SAMPLE OF ROOFING AND PRODUCT DATA SHEET FOR ARCHITECT'S AND OWNER APPROVAL. INITIAL SOLAR REFLECTANCE 0.73 3 YEAR SOLAR REFLECTANCE 0.65

FOR WATERPROOFING AND FLASHING OF ROOF MEMBRANE PENETRATIONS USE SIKA DETAILS & G459 MEMBRANES.

- 4) GUTTERS, METAL HANGERS AND DOWN SPOUTS WITH CONDUCTOR HEAD, 22 GA ZINC COATED GALV. STEEL G-90 GUTTERS TO HAVE CONTINUOUS REMOVABLE LEAF SCREEN

ALUMINUM SUN SCREIN
SUPPLIER: HANSEN
MD: STYLE 2 HONLA KAI
FINISH: TGIC POLYESTER POWDER COATING COLOR: HOUSE A AND BR- BRONZE MATT
HOUSE B - ANODIZED SILVERALUMINUM SUNSHADES. SHOP DRAWINGS REQUIRED FOR
ARCHITECTS'S AND OWNER REVIEW AND APPROVAL.

6 FCM VELUX SKYLITE - FIXED, CURB MOUNTED FOM VELOX SKITLE — FIXED, VORM MOUNTED.

CURB SITE BUILT WITH VELUX FLASHING AND ADHESNE UNDERLAYMENT.

GLAZING: DOUBLE GLASS WITH OUTBOARD 5/32" THCK TEMPERED GLASS LOW E, INBOARD LAMINATED WITH ARGON MAX U FACTOR: 0.55

MAX SHGC: 030 ER. 0199 VALID 9/2023

INSTALL PER MANUFACTURER INSTRUCTIONS. PROVIDE 10 YEARS WARRANTY

7 CONCEPTUAL PLAN FOR SOLAR ZONE IN COMPLIANCE WITH CBC 2019 & TITLE 24' AREA: 250 S.F. PANELS APROX: 5'x4'x2' SIGNAL HILL LATITUDE: 33.797337

USE MIN. ANGLE 10" TO REDUCE PROJECTION OVER ROOF RIDGE PROJECTION NOT TO EXCEED 16"

- (2) AURA ATTIC FANS MANUF: ACTIVE VENTILATION PRODUCTS

 MD# AF-10-C4, WITH SHUT-OFF SWITCH EXHAUST AIR OUT - 500 CFM

 NET FREE VENT AREA(1/300) 325 S.IN. TOTAL 2, TOTAL AREA 650 S.IN.
- 9 ATTIC VENT INTAKE IN EAVE 5.5"x22" ATTIC VENTS LOCATE EVERY FOURTH TRUSS,.
 BRANDGUARD VENTS MD: UE2051-PG WITH 1/16" MESH FOR EMBER AND BUG PROTECTION VENT AREA: 36.5 S.IN. NFVA TOTAL 22 VENTS, TOTAL AREA 803 S.IN. TRUSS JOIST BLOCKING VENT AREA 3"X10" =30" X 22=660 S.IN.
- (1) PROVIDE VENT HOLES IN TJI JOIST AND IN MICROLAM JOISTS. PROVIDE MAXIMUM ALLOWABLE QUANTITY AND DIAMETER.
 FOR ALLOWABLE HOLE SIZE AND LOCATIONS SEE MANUFACTURES INSTRUCTIONS.
 CONTRACTOR TO MEET MANUFACTURERS REQUIREMENTS. DO NOT OVER CUT HOLES, ROUND HOLES ONLY. SEE STRUCTURAL PLANS FOR JOISTS SPECIFICATIONS.
- (1) (2) LOUVERS SS WALL VENTS BRANDGUARD VENT. MD FV2011FF CUSTOMIZED STAINLESS STEEL 6X14" NEFA 23.4" TOTAL (2) WITH 1/16" MESH

TJI JOIST CROSS-VENTILATION

FOR 24" TJI SPACING PROVIDE (3) 2" DIA VENT HOLES IN EACH JOIST (3X 3.142 SQ.IN.= 9.426 S.IN.) APPROX 33 TJI X 2 X: 9.426=622 S.IN. COCATE HOLES IN MOST UPPER PART OF WEB. COMPLY WITH MANUFACTURER MIN. CLR TO JOIST FLANGES

ROOF VENT CALCULATIONS

ATTIC AREA: 2,697 S.F.
VENT RATIO: 1,1300
VENT AREA:
RECUIRED: 50% INTACE 648 SQ. IN. SEE NOTE 9
50% EXHAUST 648 SQ. IN. SEE NOTE 8

GENERAL NOTES

1. FOR GRADING AND STORMWATER DRAINAGE REFER TO CIVIL ENGINEER PLANS

LEGEND

□□□ ATTIC EAVE VENT

HOUSE "A" MODIFICATIONS - PRELIMINARY PLANS



DESIGN CONSTRUCTION SERVICES INC.

2201 E. Willow. Suite D. #319

DCS BOZENA JAWORSK
ARCHITECT EXPRESSLY RESERVES
ITS COMMON LAW COPYRIGHTS
AND OTHER PROPERTY RIGHTS IN
HEES PLANS. HEES PLANS ARE
NOT TO BE REPRODUCED
CHANGED OR COPIED IN ANY
FORM OR MANNER WHATSOEVER
TOR ARE HEY TO BE ASSIGNED
TOR ARE HEY TO BE ASSIGNED
TOR ARE THEY TO BE ASSIGNED
TOR ARE THEY TO BE ASSIGNED
TOR AND CONSENT OF
THE DCS ARCHITECT

PROJECT #4921

REVISIONS

02-01-2024 CLIENT REVIEW MODIF. DUE TO WELL DISCOVE

4-18-25 SUBMIT MODIFIED PLANS TO PLANNING DEPT. REVIEW

5-2-25 PLANNING RELEASE FO

SITE ADDRESS

2750 E. 20TH ST. SIGNAL HILL, CA. 90755


OWNER


NARSIMHA REDDY 123 ATLANTIC AVE LONG BEACH, CA.90802

> HOUSE A **ROOF PLAN**

SHEET TITLE

HOUSE A

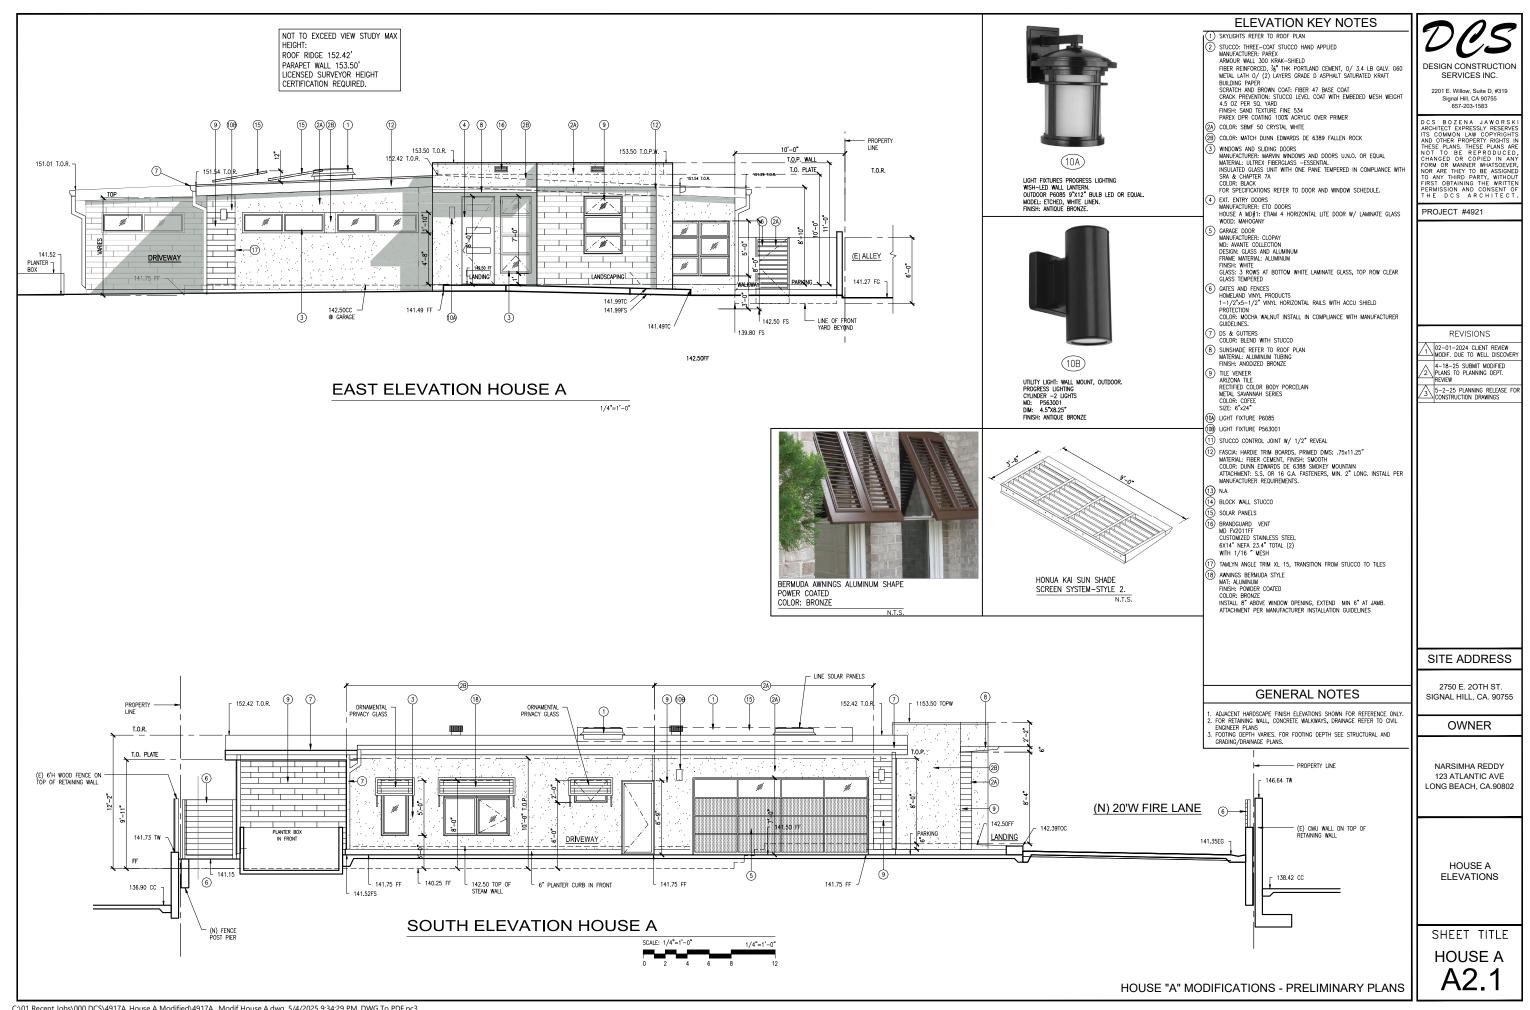

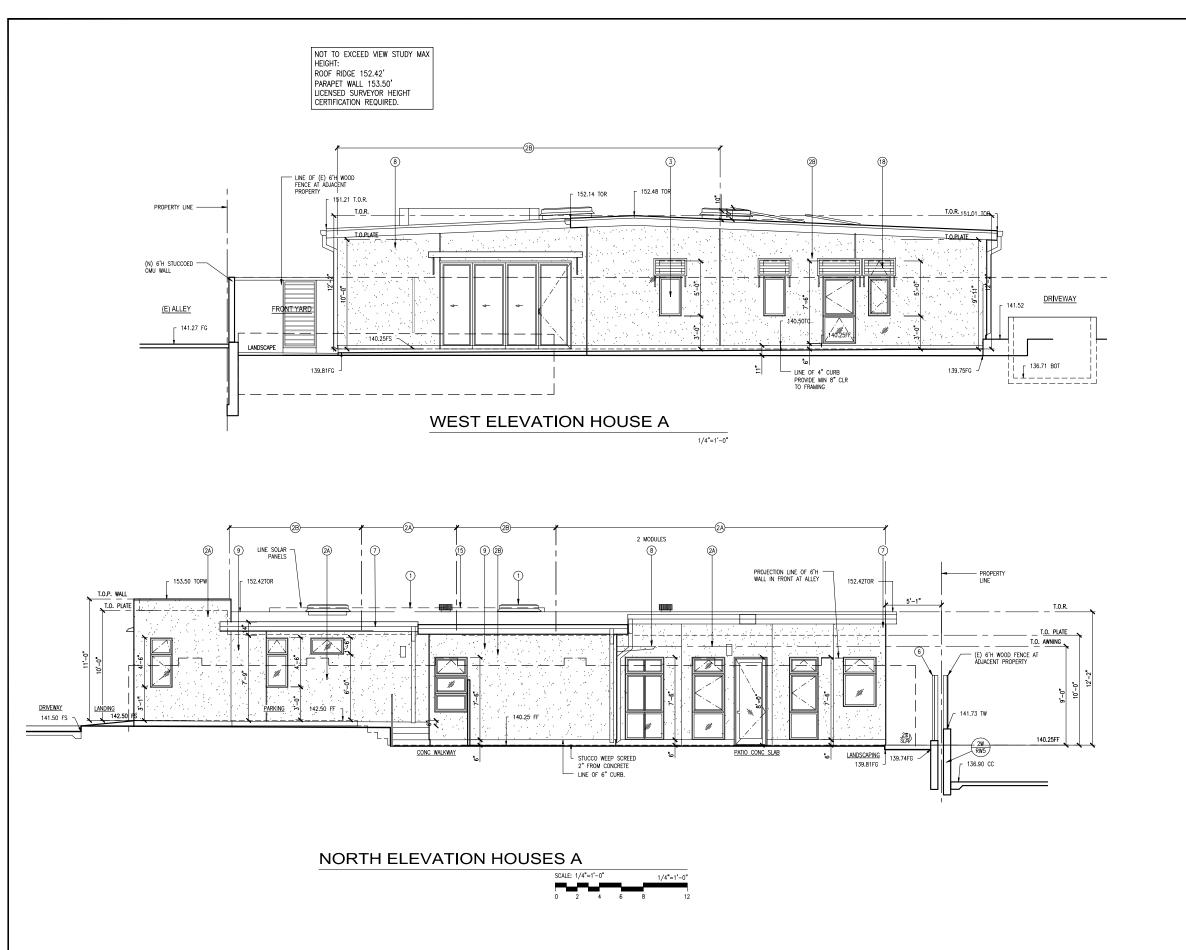

ELEVATION KEY NOTES

SKYLIGHTS REFER TO ROOF PLAN

2) STUCCO: THREE-COAT STUCCO HAND APPLIED MANUFACTURER: PAREX ARMOUR WALL 300 KRAK-SHIELD FIBER REINFORCED, 1/6" THK PORTLAND CEMENT, 0/ 3.4 LB GALV. G60
METAL LATH 0/ (2) LAYERS GRADE D ASPHALT SATURATED KRAFT

MEIAL LAH DY (2) LYPENS GRADE D ASPHALI SATUKATED KRAFT BULDING PAPER SCRATCH AND BROWN COAT: FIBER 47 BASE COAT CRACK PREVENTION: STUCCO LEVEL COAT WITH EMBEDED MESH WEIGHT 4.5 0Z PER SQ. YARD FINISH: SAND TEXTURE, FINE 534 PAREX DPR COATING 100% ACRYLIC OVER PRIMER

2A) COLOR: SBMF 50 CRYSTAL WHITE

2B) COLOR: MATCH DUNN EDWARDS DE 6389 FALLEN ROCK

MINDOWS AND SLDING DOORS
MANUFACTURER: MARVIN WINDOWS AND DOORS U.N.O. OR EQUAL
MATERIAL: ULTREX FIBERGLISS —ESSENTIAL
INSULATED GLASS UNIT ONE PANE TEMPERED IN COMPLIANCE WITH
SRA & CHAPTER 7A
COLOR: BLBCK
FOR SPECIFICATIONS REFER TO DOOR AND WINDOW SCHEDULE.

EXT. ENTRY DOORS
 MANUFACTURER: ETO DOORS
 HOUSE A MD#1: ETIAM 4 HORIZONTAL LITE DOOR W/ LAMINATE GLASS
 WOOD: MAHOGANY

(5) GARAGE DOOR
MANUFACTURER: CLOPAY
MD: AVANTE COLLECTION
DESIGN: GLASS AND ALUMINUM
FRAME MATERIAL: ALUMINUM
FINISH: WHITE FINISH: WHITE
GLASS: 3 ROWS AT BOTTOM WHITE LAMINATE GLASS, TOP ROW CLEAR
GLASS TEMPERED

GLASS INMERCED

GATES AND FENCES
HOMELAND WITH PRODUCTS
1-1/2"-55-1/2" VINYL HORIZONTAL RAILS WITH ACCU SHIELD
PROTECTION
COLOR: MOCHA WALNUT INSTALL IN COMPLIANCE WITH MANUFACTURER
GUIDELINES.

7 DS & GUTTERS COLOR: BLEND WITH STUCCO

SUNSHADE REFER TO ROOF PLAN MATERIAL: ALUMINUM TUBING FINISH: ANODIZED BRONZE

Inidist: Anodized Bronze

Tile Veneer
Arizona Tile
Rectified Color Body Porcelain
Metal Savannah Series
Color: Cofee
Size: 6*x24*

(10A) LIGHT FIXTURE P6085

(10B) LIGHT FIXTURE P563001

STUCCO CONTROL JOINT W/ 1/2" REVEAL

FASCIA: HARDIE TRIM BOARDS, PRIMED DIMS: .75x11.25"
 MATERIAL: FIBER CEMENT, FINISH: SMOOTH
 COLOR: DUNN EDWARDS DE 6388 SMOKEY MOUNTAIN
 ATTACHMENT: S.S. OR 16 G.A. FASTENERS, MIN. 2" LONG. INSTALL PER
 MANUFACTURER REQUIREMENTS.

13) N.A.

14) BLOCK WALL STUCCO SOLAR PANELS

6 BRANDGUARD VENT
MD FV2011FF
CUSTOMIZED STAINLESS STEEL
6X14" NEFA 23.4" TOTAL (2)
WITH 1/16 " MESH

TAMILYN ANGLE TRIM XL 15, TRANSITION FROM STUCCO TO TILES

MAINTON SERMUDA STYLE
MAY AUGUST SERMUDA STYLE
MAY AUGUST STYLE
MAY AUGUST

SITE ADDRESS

GENERAL NOTES

- ADJACENT HARDSCAPE FINISH ELEVATIONS SHOWN FOR REFERENCE ONLY.
 FOR RETAINING WALL, CONCRETE WALKWAYS, DRAINAGE REFER TO CIVIL ENGINEER PLAN VARIES. FOR FOOTING DEPTH SEE STRUCTURAL AND GRADING/DRAINAGE PLANS.

DESIGN CONSTRUCTION SERVICES INC.

2201 E. Willow, Suite D. #319

DCS BOZENA JAWORSK ARCHITECT EXPRESSLY RESERVES ITS COMMON LAW COPYRIGHTS AND OTHER PROPERTY RIGHTS IN HEES PLANS. HEES PLANS ARE NOT TO BE REPRODUCED, CHANGED OR COPIED IN ANY FORM OR MANNER WHATSOEVER, TO ARE THEY TO BE ASSIGNED TO ARE THEY TO BE ASSIGNED TO ARE THEY TO BE ASSIGNED PERMISSION AND CONSENT OF THE D CS ARCHITECT.

PROJECT #4921

REVISIONS

02-01-2024 CLIENT REVIEW MODIF. DUE TO WELL DISCOVER

4-18-25 SUBMIT MODIFIED PLANS TO PLANNING DEPT. REVIEW

5-2-25 PLANNING RELEASE FO

2750 E. 20TH ST.

SIGNAL HILL, CA. 90755

OWNER


NARSIMHA REDDY 123 ATLANTIC AVE LONG BEACH, CA.90802


> HOUSE A **ELEVATIONS**


SHEET TITLE

HOUSE A A2.2

HOUSE "A" MODIFICATIONS - PRELIMINARY PLANS

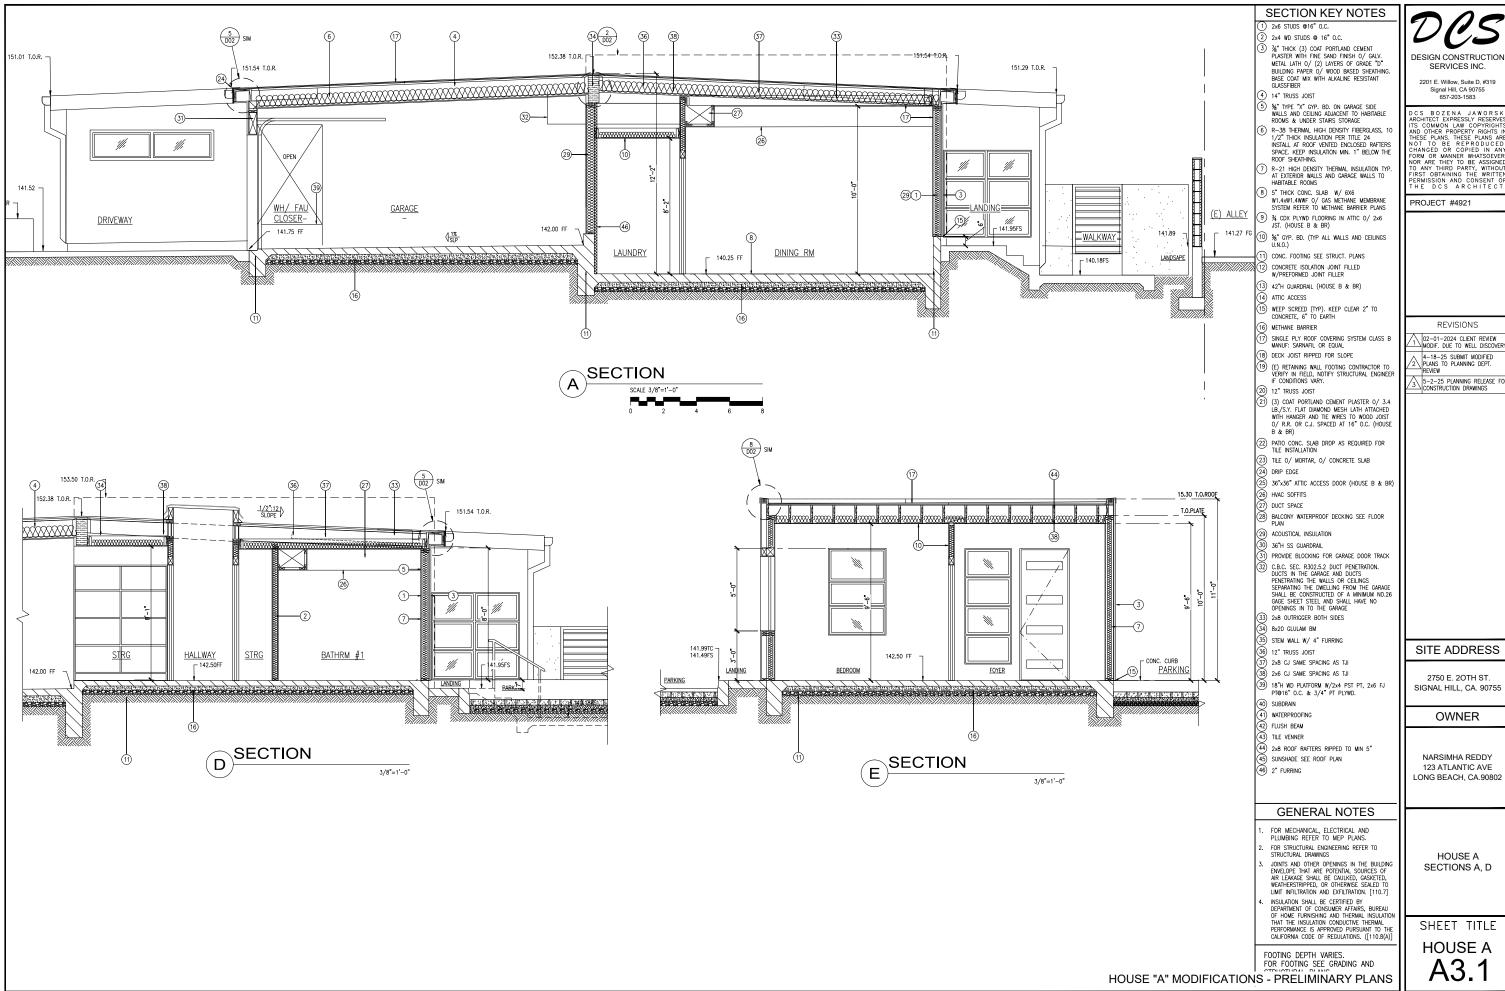

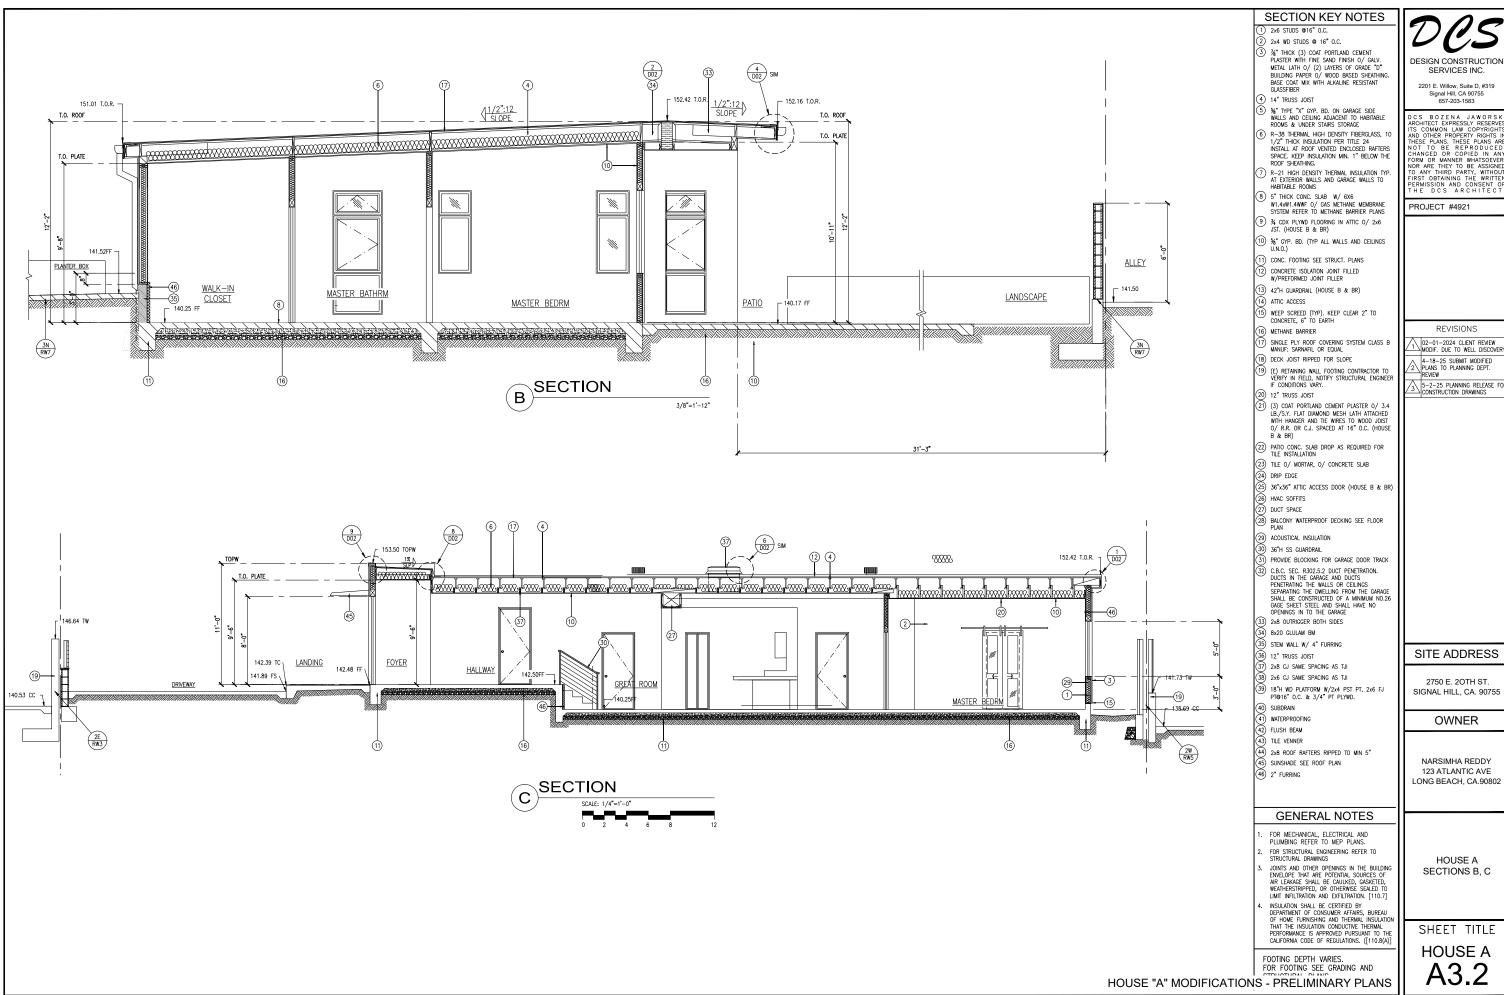

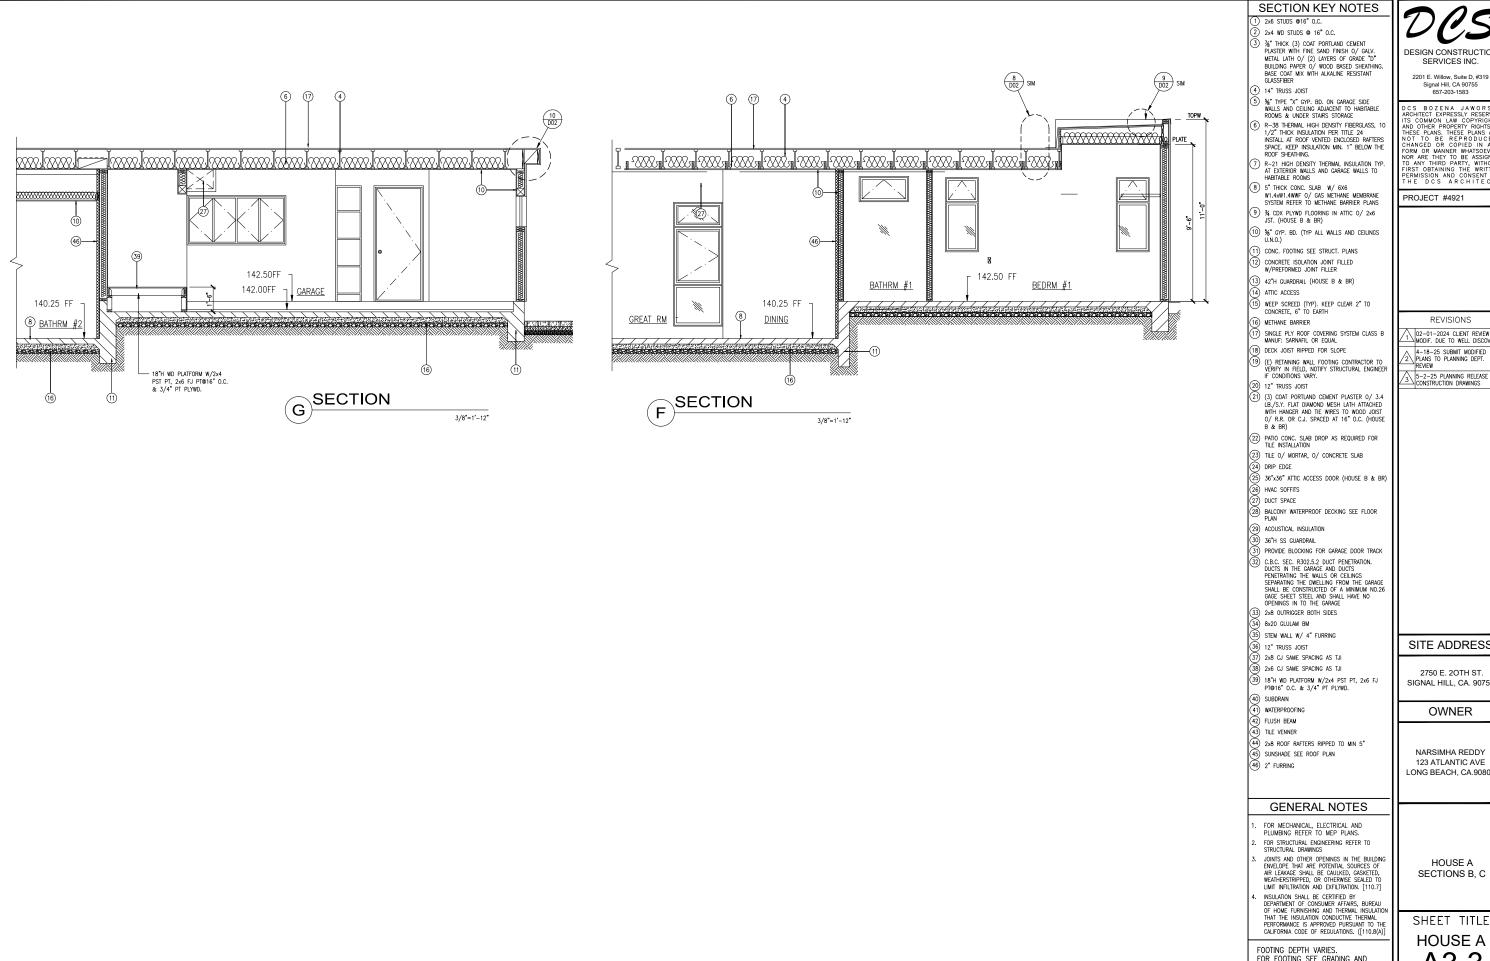

FOOTING DEPTH VARIES.
FOR FOOTING SEE GRADING AND

HOUSE "A" MODIFICATIONS - PRELIMINARY PLANS

DESIGN CONSTRUCTION SERVICES INC.

DCS BOZENA JAWORSK ARCHIECT EXPRESSLY RESERVES ITS COMMON LAW COPYRIGHTS AND OTHER PROPERTY RIGHTS IN THESE PLANS. THESE PLANS IN THESE PLANS. THESE PLANS RO TO BE REPRODUCED CHANGED OR COPIED IN A FORM OR MANNER WHATSOEVER MOR ARE THEY TO BE ASSIGNEE OF AND THEY OR THEY FORM OR THEY TO BE ASSIGNEE FORM OF THE TO BE ASSIGNEE THEY OF THE TO BE ASSIGNED THE TO BE ASS

REVISIONS

02-01-2024 CLIENT REVIEW MODIF. DUE TO WELL DISCOVER

5-2-25 PLANNING RELEASE FO CONSTRUCTION DRAWINGS

SITE ADDRESS

2750 E. 20TH ST. SIGNAL HILL, CA. 90755

NARSIMHA REDDY 123 ATLANTIC AVE LONG BEACH, CA.90802

> HOUSE A SECTIONS B, C

SHEET TITLE

A3.3